



Lower Thames Crossing

2.6 Works Plans

**Volume B Composite (sheets 1
to 20)**

APFP Regulation 5(2)(j)

Infrastructure Planning (Applications:
Prescribed Forms and Procedure)
Regulations 2009

Volume 2

DATE: October 2022

Planning Inspectorate Scheme Ref: TR010032
Application Document Ref: TR010032/APP/2.6

VERSION: 1.0

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1 Introduction

- 1.1.1 This document is submitted to the Planning Inspectorate on behalf of the Secretary of State in relation to an application made by National Highways (the Applicant) under section 37 of the Planning Act 2008.
- 1.1.2 The Application is for the grant of development consent for the A122 Lower Thames Crossing. Should development consent be granted, the draft A122 (Lower Thames Crossing) Development Consent Order (Application Document 3.1) (the draft Order") will be made by the Secretary of State for Transport (subject to any modifications considered appropriate).
- 1.1.3 This document comprises part of the suite of application documentation and is included in the application to comply with Regulations 5(2)(j) and 5(4) of the Infrastructure Planning (Applications: Prescribed Forms and Procedure) Regulations 2009, which require:
- 5(2)(j) '*a works plan showing, in relation to existing features:*
- (i) *the proposed location or (for a linear scheme) the proposed route and alignment of the development and works; and*
- (ii) *the limits within which the development and works may be carried out and any limits of deviation provided for in the draft order.*
- 5(4) *Where a plan comprises three or more separate sheets a key plan must be provided showing the relationship between the different sheets.'*
- 1.1.4 The purpose of the Works Plans is to illustrate the location and extent of the works for which development consent is sought as described in Schedule 1 of the draft Order (Application Document 3.1). The Applicant has sought to describe the works in Schedule 1 applying, whenever necessary, separate sub-work numbers to provide clarity.
- 1.1.5 In order to assist the interpretation of the Works Plans, the Applicant has prepared Composite sheets, which show all of the works for that sheet, and Utilities sheets, which show only the utility works from the Composite sheet.
- 1.1.6 It should be noted that, for consistency, the Applicant has prepared the Utilities sheets for the entire set.
- 1.1.7 As the Works Plans have been informed by and are part of the application documentation, they should be read alongside the other application documents. In particular, the Works Plans should be read alongside the following:
- Schedule 1 of the draft Order (Application Document 3.1)
 - Land Plans (Application Document 2.2)
 - Rights of Way and Access Plans (Application Document 2.7)
 - Engineering Drawings and Sections Plans (Application Document 2.9)
 - Structures Plans (Application Document 2.13)
 - Temporary Works Plans (Application Document 2.17)

- 1.1.8 Each sheet shows the relevant works numbers applicable within the area shown. Reference should be made to the next relevant sheet for details of works numbers beyond the cut lines. Other information on the Works Plans is shown beyond the cut lines for completeness and context.
- 1.1.9 The Works Plans show the Order Limits and the relevant local authority boundaries for clarity. In this plan set, ‘the Order Limits’ mean the limits of lands to be acquired or used, permanently or temporarily, within which the authorised development may be carried out (see article 2 of the draft Order (Application Document 3.1)).
- 1.1.10 The Works Plans show the centreline for each length of the proposed highway work or linear utility diversion, as well as the boundary for other non-linear works. The proposed highway works centreline is shown in a black dashed line and comprises the road works including streets, public rights of way and private means of access.
- 1.1.11 The proposed diversion or modification of overhead lines is shown in a purple solid line and the temporary diversion alignment is shown in a purple dashed line. The existing overhead lines to be removed as part of the works is shown in a grey dashed line. The proposed underground diversion alignment for gas is shown in an orange solid line and the proposed gas alignment to be removed is shown in orange dashed line. The proposed underground diversion alignment for multi-utilities is shown in blue solid line and the above ground multi-utility compounds are shown in a black box identified as ‘substation SS’. The proposed temporary underground diversion alignment for multi-utilities is shown in light blue solid line.
- 1.1.12 The major proposed structures are highlighted with a black solid box and include structures along the Project mainline and the ground protection tunnel. All these structures have been assigned their own work number, described in Schedule 1 of the draft Order (Application Document 3.1).
- 1.1.13 The Works Plans show the areas proposed in the environmental design as new areas to provide mitigation or compensation for the impacts of the Project as black arrow shaded areas. The areas necessary for floodplain compensation are shown as a blue dotted shaded area.
- 1.1.14 The Works Plans indicate the location of temporary construction compounds and working sites, listed as numbered works in Schedule 1. A separate set of Temporary Works Plans (Application Document 2.17) has been prepared to show the location and extent of temporary works, including temporary roads for construction access.
- 1.1.15 The design is shown in the background on the Works Plans for illustrative purposes and specifically to provide context and aid understanding of the works. As indicated in the legend, the proposed structures are shown as two solid grey lines; this includes the proposed bridges, viaducts, overbridges, underbridges and retaining walls. It should be noted that proposed bridges, viaducts, overbridges and underbridges are described as a sub-work of a highways linear work in Schedule 1 of the draft Order (Application Document 3.1). For other elements of the works that cannot be separately distinguished from a work or broken down, such as retaining walls, highway drainage ditches and swales, embankments and cuttings earthworks, the Applicant has included

these in the list of ancillary works as described in Schedule 1 of the draft Order (Application Document 3.1).

- 1.1.16 The proposed drainage culverts are represented in a specific way, as shown in the legend, in an approach consistent with the General Arrangement Plans (Application Document 2.5).
- 1.1.17 The commencement and termination of the proposed highways linear works are graphically represented on the plan by different black markers in the shape of bowties (one solid, one hollow). The Applicant has made every effort to represent the bowtie entirely within the Order Limits boundary wherever possible but due to the size of this graphic, this is sometimes unachievable. It is important to note that the start and end points of the works are all within the Order Limits and are defined by the reference points listed in Schedule 1 of the draft Order (Application Document 3.1) and shown in Rights of Way and Access Plans (Application Document 2.7).
- 1.1.18 Article 6 of the draft Order (Application Document 3.1) provides for a lateral deviation from the lines or situations shown on the Works Plans to the extent of the defined limits of deviation. This is to provide the Applicant with a limited and proportionate degree of flexibility to allow for detailed design development. The vertical limits of deviation are described in Article 6 of the draft Order (Application Document 3.1).
- 1.1.19 The highway works lateral limits of deviation are shown as areas of shaded green on the Composite sheets and the limits of deviation for utility works are indicated by striped areas on the Composite and Utilities sheets as: purple for overhead electricity lines works, orange for gas works, blue for underground multi-utility works and light blue for temporary overhead and multi-utility works. Where relevant, the lateral limits of deviation shown in the Works Plans have been determined considering a range of factors, including earthworks, structures and drainage features. The lateral limits of deviation for tunnels works, such as the tunnel portal structures (south and north), the bored tunnels and the tunnel service buildings are show as part of the highways lateral limits of deviation and also shown in detail in the Tunnel Limits of Deviation Plans (Application Document 2.15).
- 1.1.20 Further information about the limits of deviation is provided in the Introduction to the Application (Application Document 1.3). The information shown on the plans is for illustrative purposes only to show the proposed design of the Project and would be subject to detailed design. Detailed design would be in accordance with the extent of the defined limits of deviation provided in the draft Order and any approval required under the requirements set out in Schedule 2 of the draft Order (Application Document 3.1).
- 1.1.21 It should be recognised that there are some instances where the extent of a work shown in the Works Plans and described in Schedule 1 of the draft Order (Application Document 3.1) may differ from the extents provided elsewhere in the draft Order, namely in Schedules 3 and 4 (Application Document 3.1). This is because, in some cases, new public rights of way may be created by a combination of works or the creation of a new public rights of way may be divided into several works. The corresponding commencement and termination points of all the works shown in the Works Plans have a corresponding

reference point in the Rights of Way and Access Plans (Application Document 2.7).

- 1.1.22 To ensure sufficient detail and clarity of information, the Works Plans (sheets 1 to 49) have been prepared at a scale of 1:2500. The key plan uses a smaller scale than that prescribed in Regulation 5(3) of the 2009 Regulations so that the Project can be represented in a single sheet plan.
- 1.1.23 The Applicant has adopted the same approach for the Works Plans as has been used for the following:
- a. Land Plans (Application Document 2.2)
 - b. Crown Land Plans (Application Document 2.3)
 - c. Special Category Land Plans (Application Document 2.4)
 - d. General Arrangement Plans (Application Document 2.5)
 - e. Rights of Way and Access Plans (Application Document 2.7)
 - f. Streets Subject to Temporary Restrictions of Use Plans (Application Document 2.8)
 - g. Traffic Regulation Measures Plans (Application Document 2.10)
 - h. Drainage Plans (Application Document 2.16)
 - i. Temporary Works Plans (Application Document 2.17)
 - j. Hedgerows and Tree Preservation Order Plans (Application Document 2.18)
- 1.1.24 The information contained on each sheet of the Works Plans corresponds with the information shown on each sheet of the aforementioned sets. This is intended to help interested parties understand the inter-relationship between the different sets of plans and to help illustrate the design of the Project more clearly.
- 1.1.25 It is important to note that there are locations within the DCO boundary where no works are shown on the Works Plans. A number of reasons could account for this, for example, the land may be required temporarily to provide sufficient working space during construction.
- 1.1.26 This plan set uses a consistent key applicable to the plan set as a whole, rather than being tailored to each individual sheet. This means that there may be some items shown in the key that are not on a given sheet.
- 1.1.27 To ensure that the file size of this document does not exceed the 50MB limit prescribed by the Planning Inspectorate, the set has been split into six volumes: three separate volumes (volume A contains the key plan, volume B contains the initial sheets 1 to 20 and volume C contains sheets 21 to 49 for the composite plans) and three further separate volumes (volumes A, B and C) for the utilities works.

2 Schedule of Plans included in this application document

Document Title	Document Number	Revision
WORKS PLANS REGULATION 5(2)(j) KEY PLAN – COMPOSITE	TR010032/APP/2.6	P01
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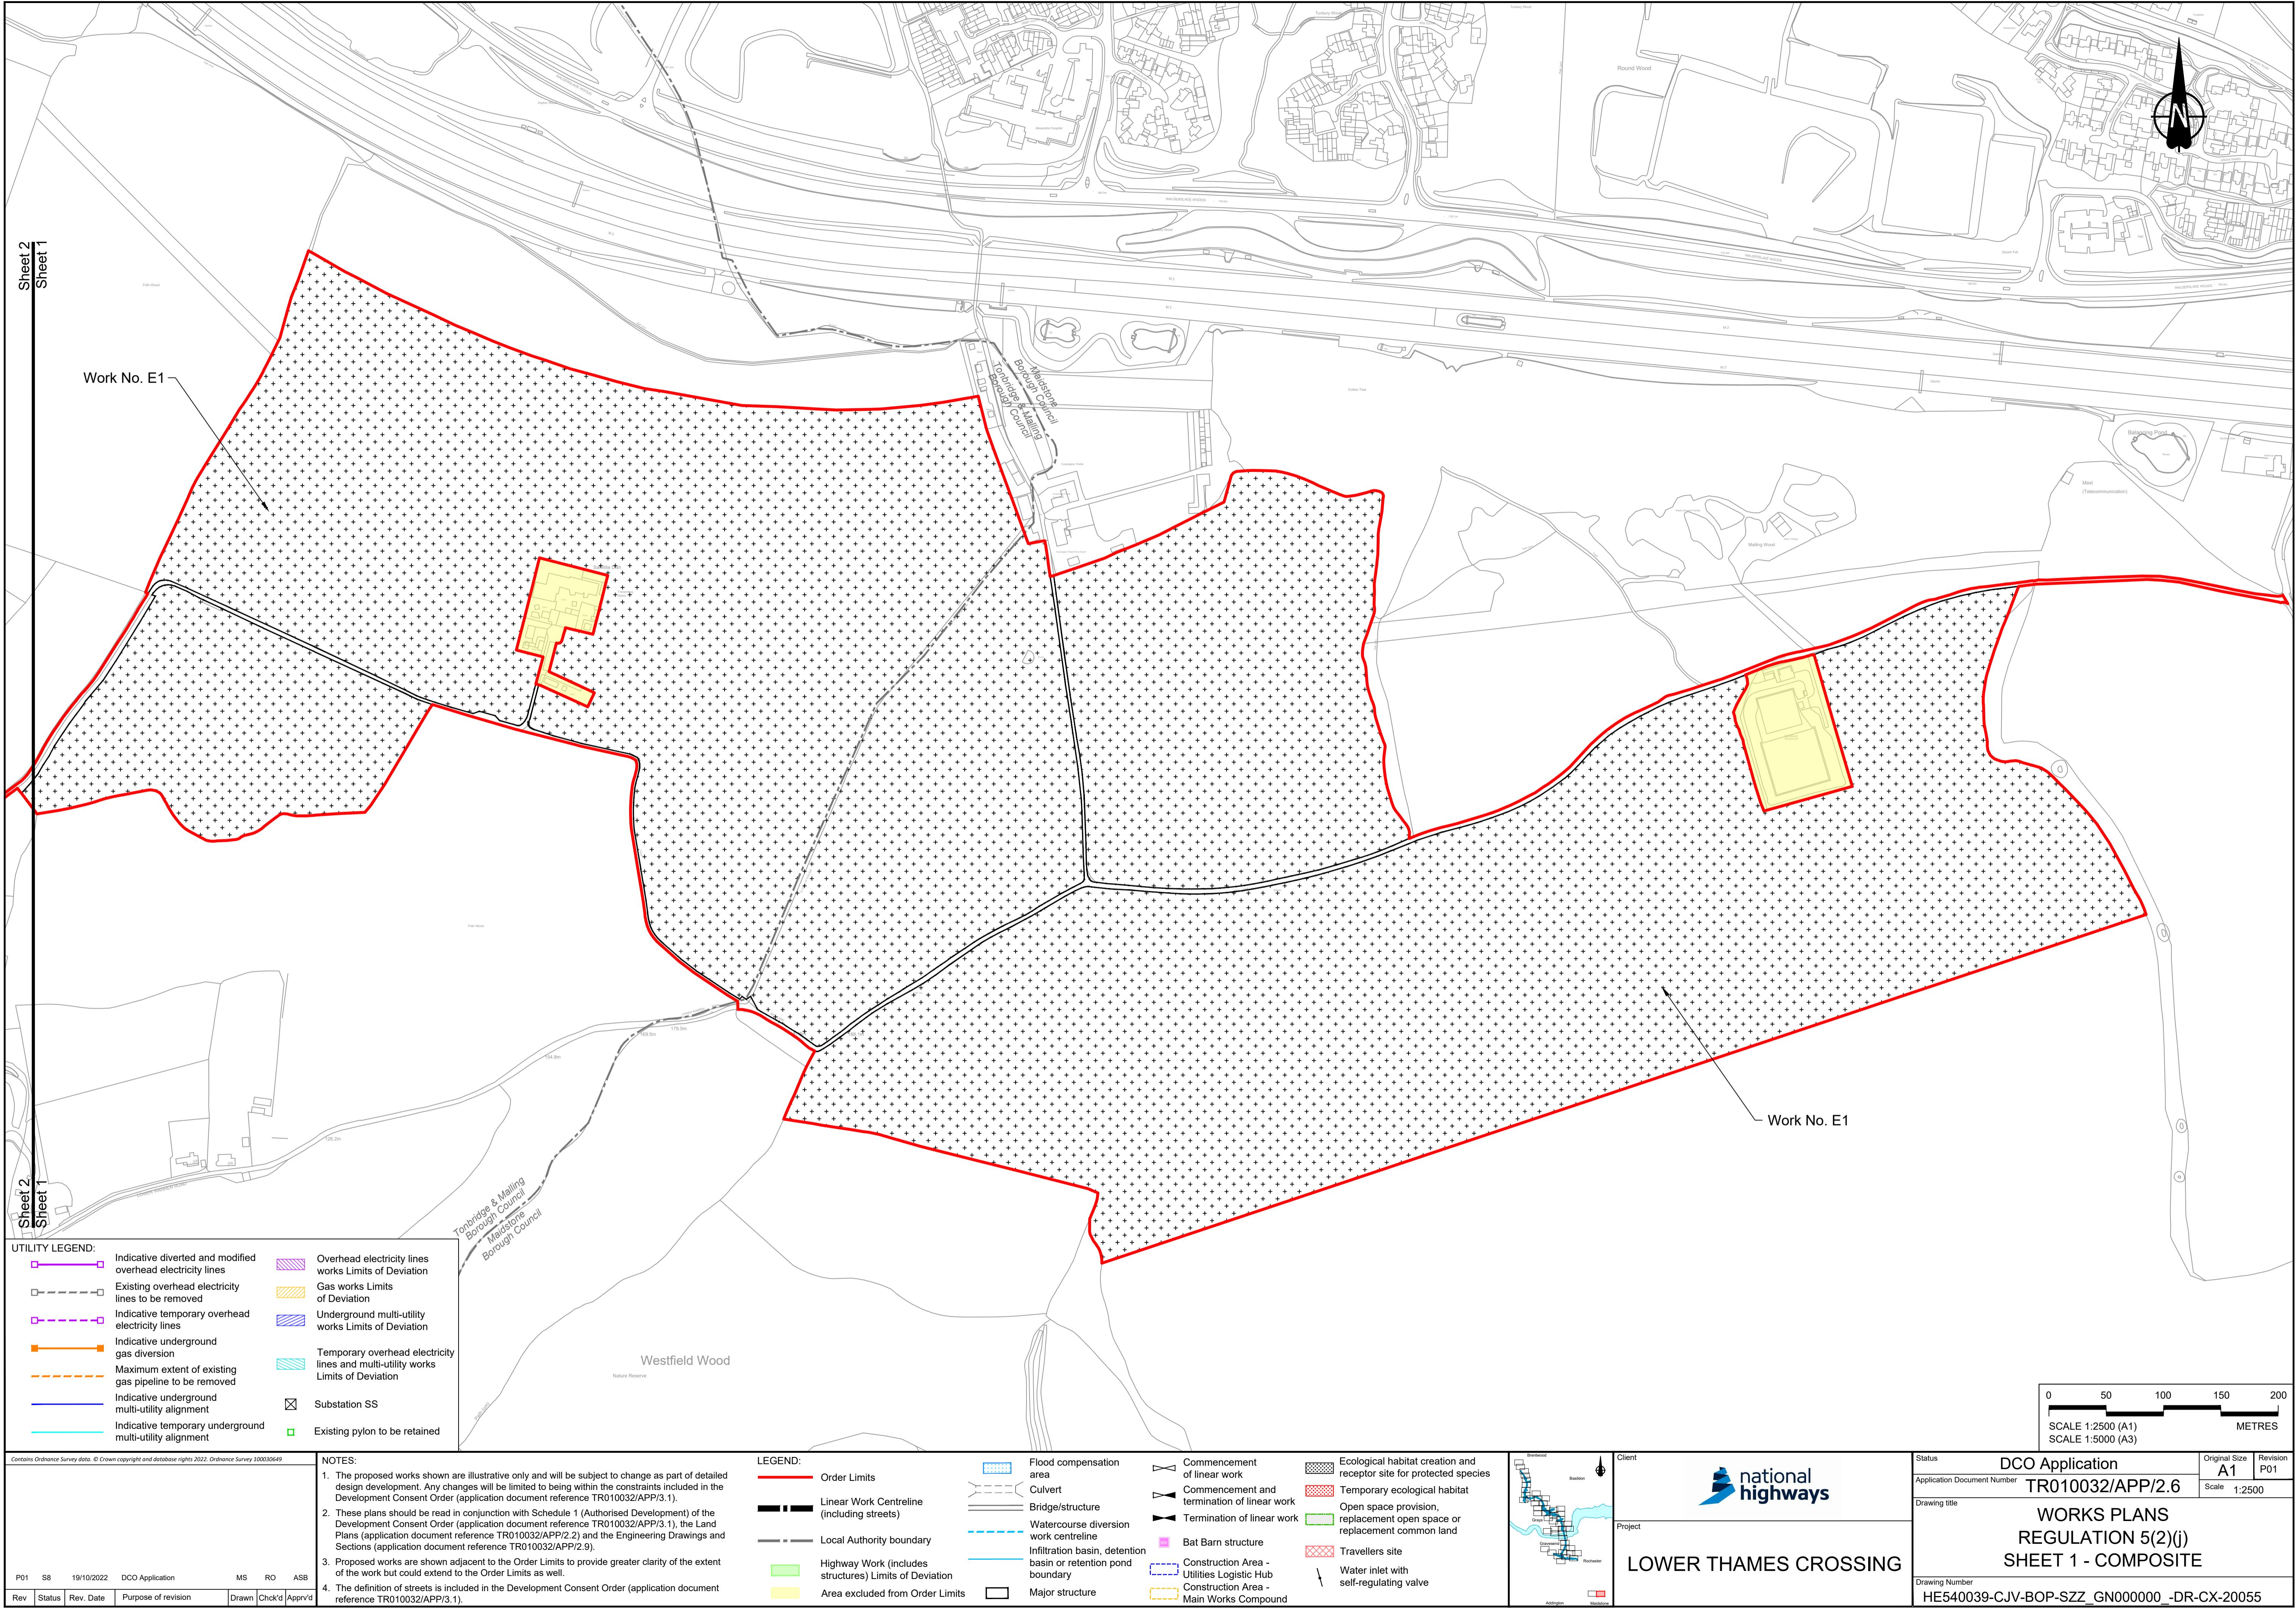
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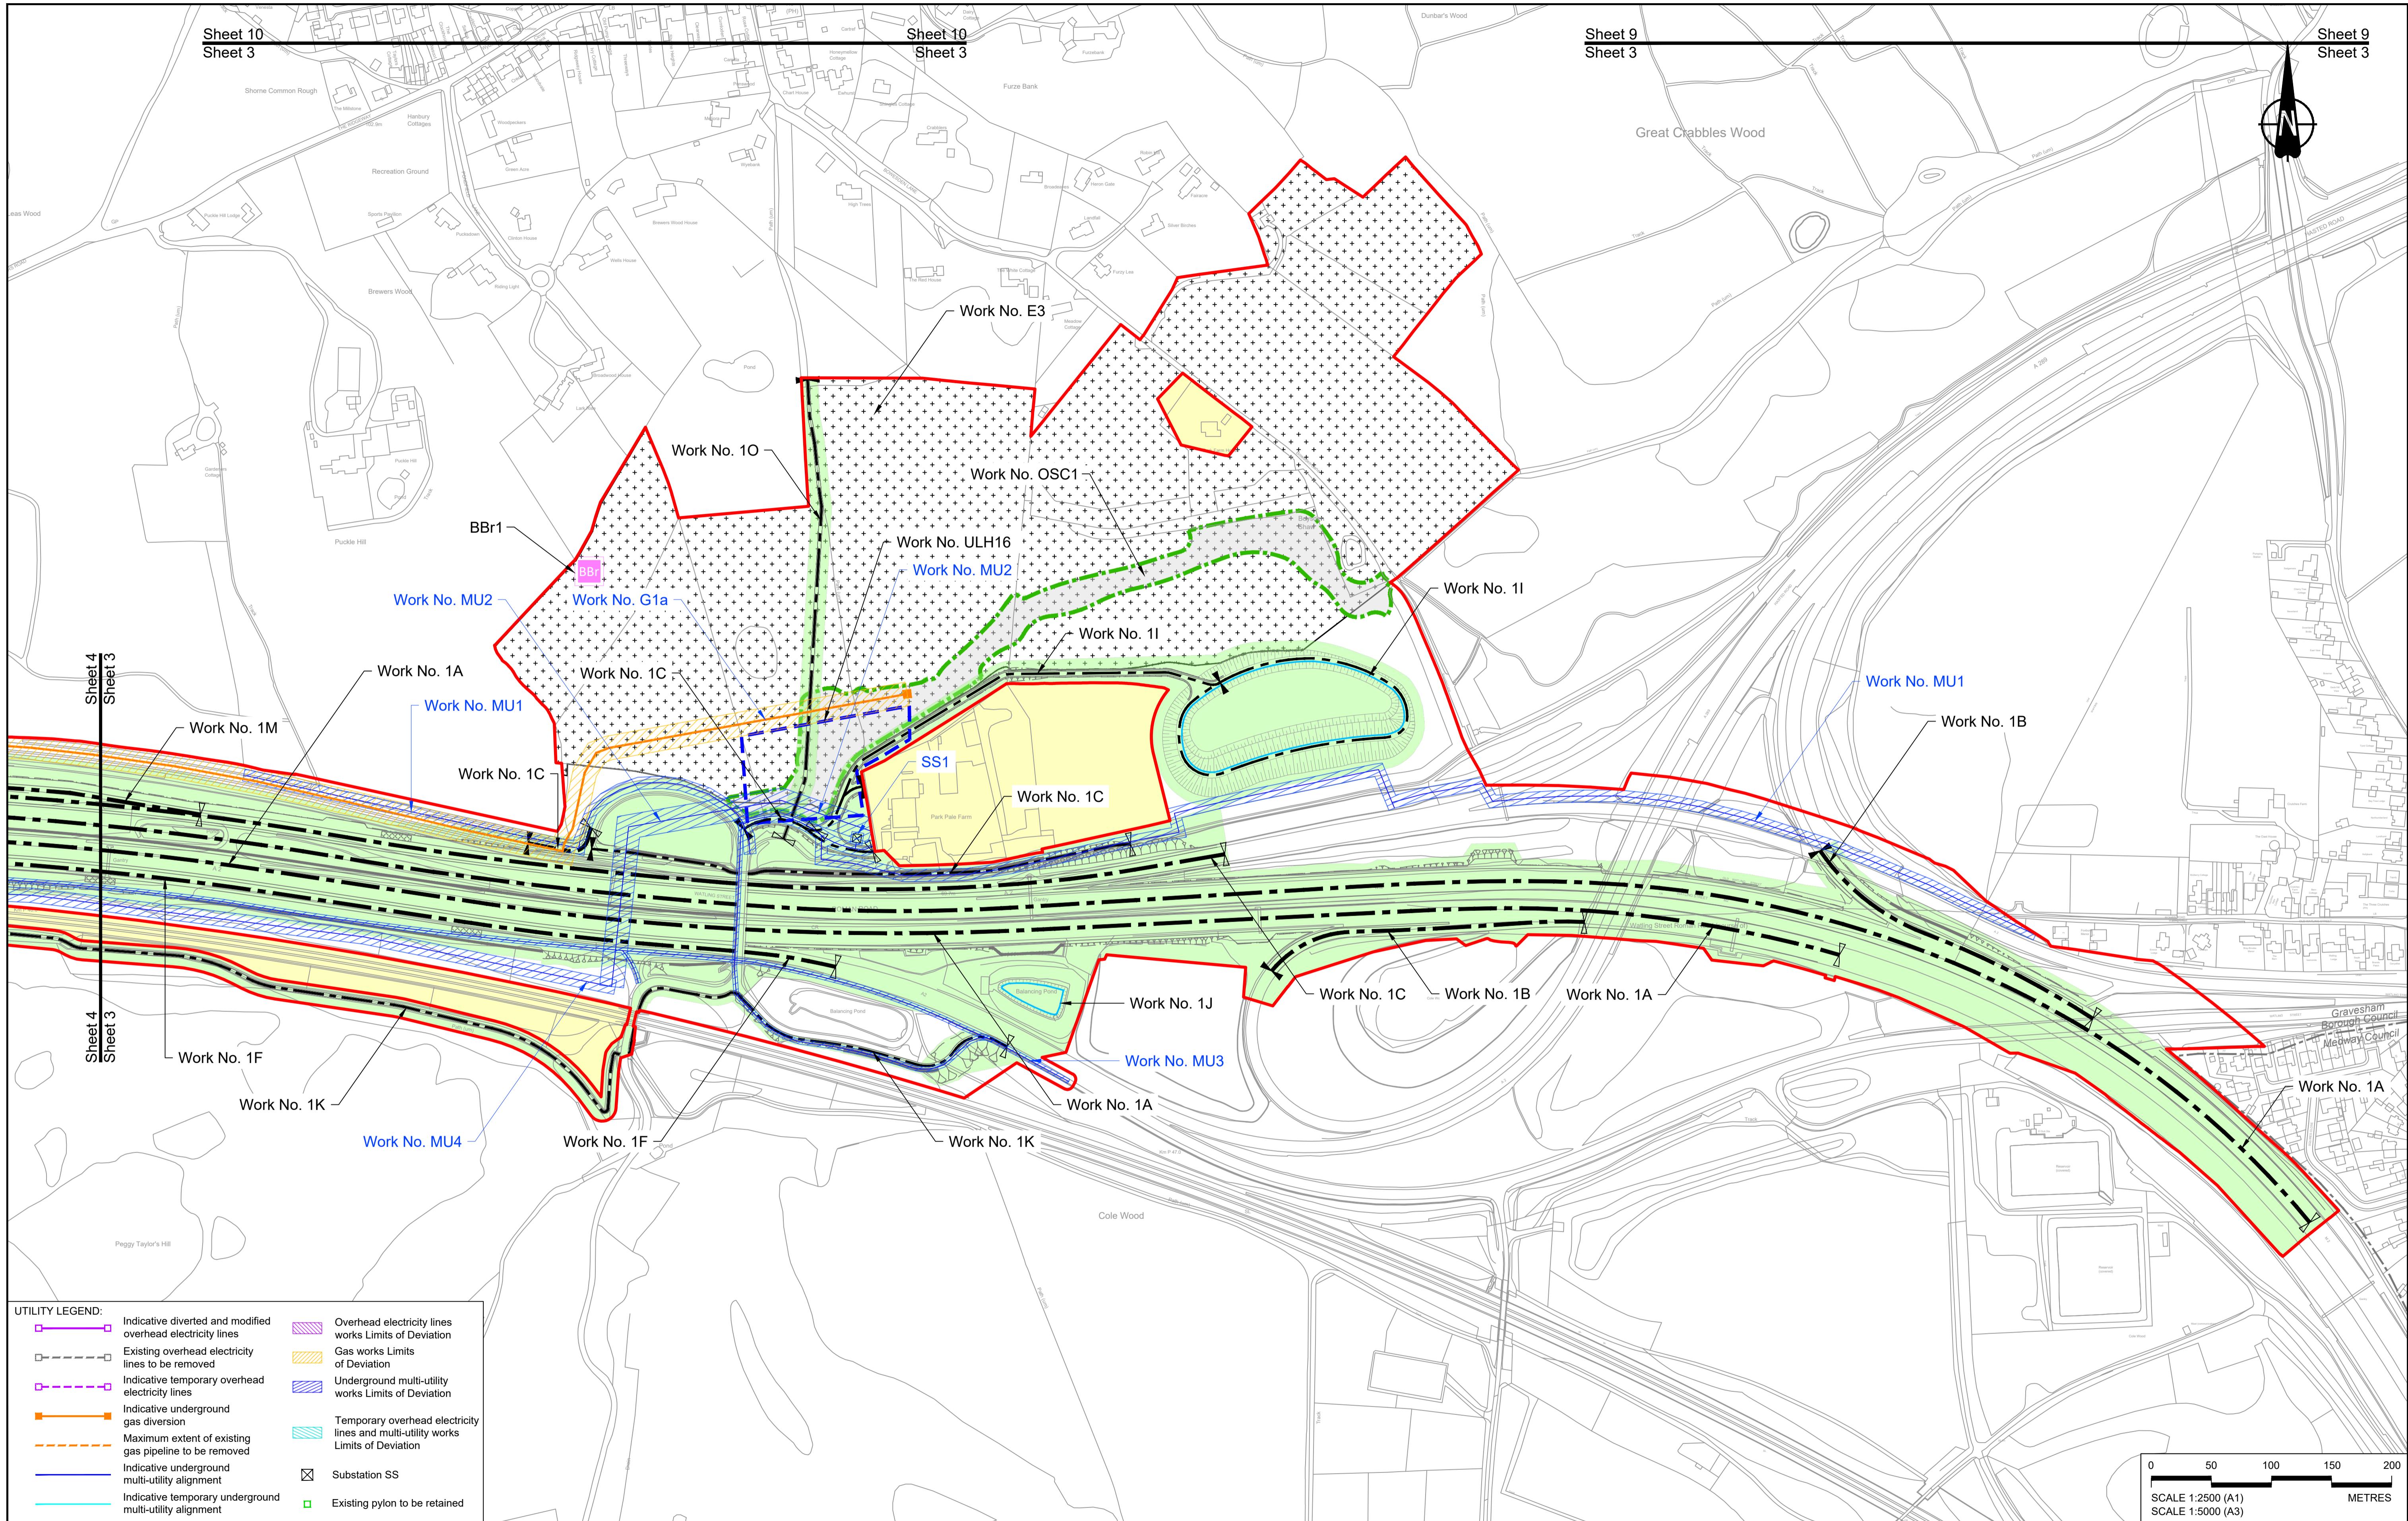
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- NOTES:**
- The proposed works shown are illustrative only and will be subject to change as part of detailed design development. Any changes will be limited to being within the constraints included in the Development Consent Order (application document reference TR010032/APP/3.1).
 - These plans should be read in conjunction with Schedule 1 (Authorised Development) of the Development Consent Order (application document reference TR010032/APP/3.1), the Land Plans (application document reference TR010032/APP/2.2) and the Engineering Drawings and Sections (application document reference TR010032/APP/2.9).
 - Proposed works are shown adjacent to the Order Limits to provide greater clarity of the extent of the work but could extend to the Order Limits as well.
 - The definition of streets is included in the Development Consent Order (application document reference TR010032/APP/3.1).


- LEGEND:**
- Order Limits
 - Linear Work Centreline (including streets)
 - Local Authority boundary
 - Highway Work (includes structures) Limits of Deviation
 - Area excluded from Order Limits
 - Flood compensation area
 - Culvert
 - Bridge/structure
 - Watercourse diversion work centreline
 - Infiltration basin, detention basin or retention pond boundary
 - Major structure
 - Commencement of linear work
 - Commencement and termination of linear work
 - Termination of linear work
 - Bat Barn structure
 - Construction Area - Utilities Logistic Hub
 - Construction Area - Main Works Compound
 - Ecological habitat creation and receptor site for protected species
 - Temporary ecological habitat
 - Open space provision, replacement open space or replacement common land
 - Travellers site
 - Water inlet with self-regulating valve

P01 S8 19/10/2022 DCO Application MS RO ASB

Rev Status Rev. Date Purpose of revision Drawn Chkd'd Apprv'd

Status	DCO Application	Original Size A1	Revision P01
Application Document Number	TR010032/APP/2.6	Scale	1:2500
Drawing title	WORKS PLANS		
	REGULATION 5(2)(j)		
Project	LOWER THAMES CROSSING		
Drawing Number	HE540039-CJV-BOP-SZZ_GN000000_DR-CX-20001		

HE540039-CJV-BOP-SZZ_GN000000_DR-CX-20001.dwg

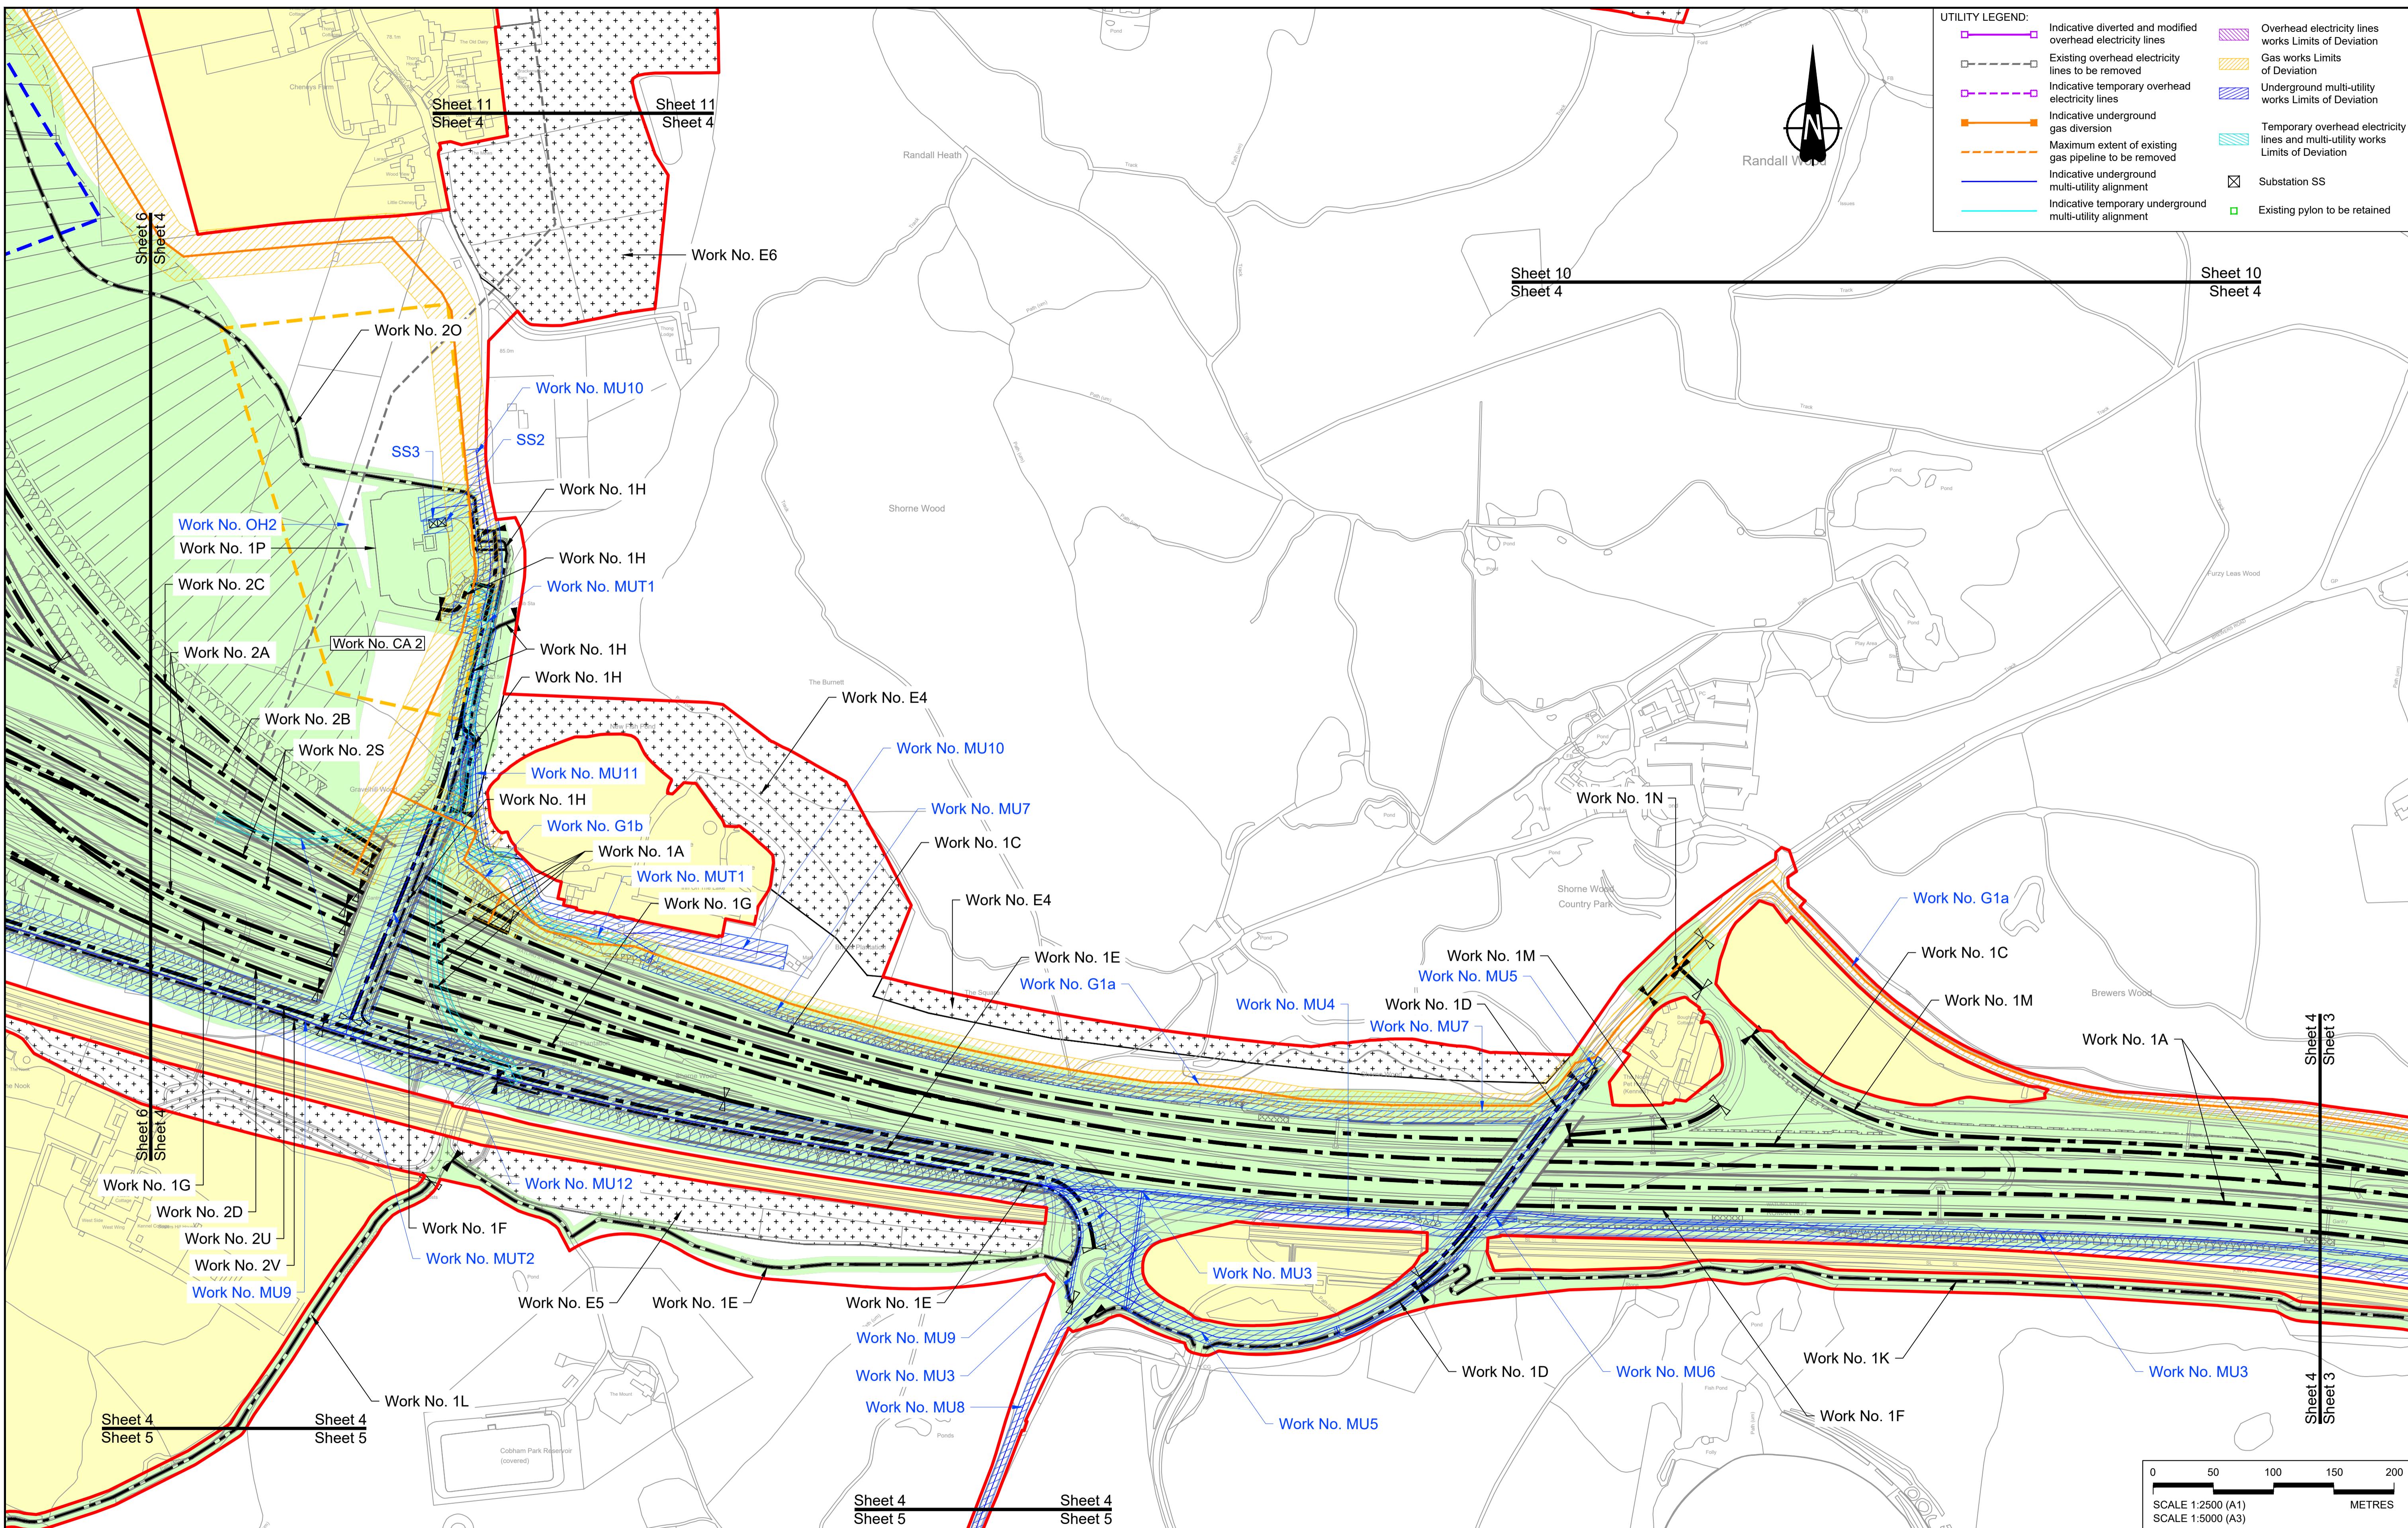

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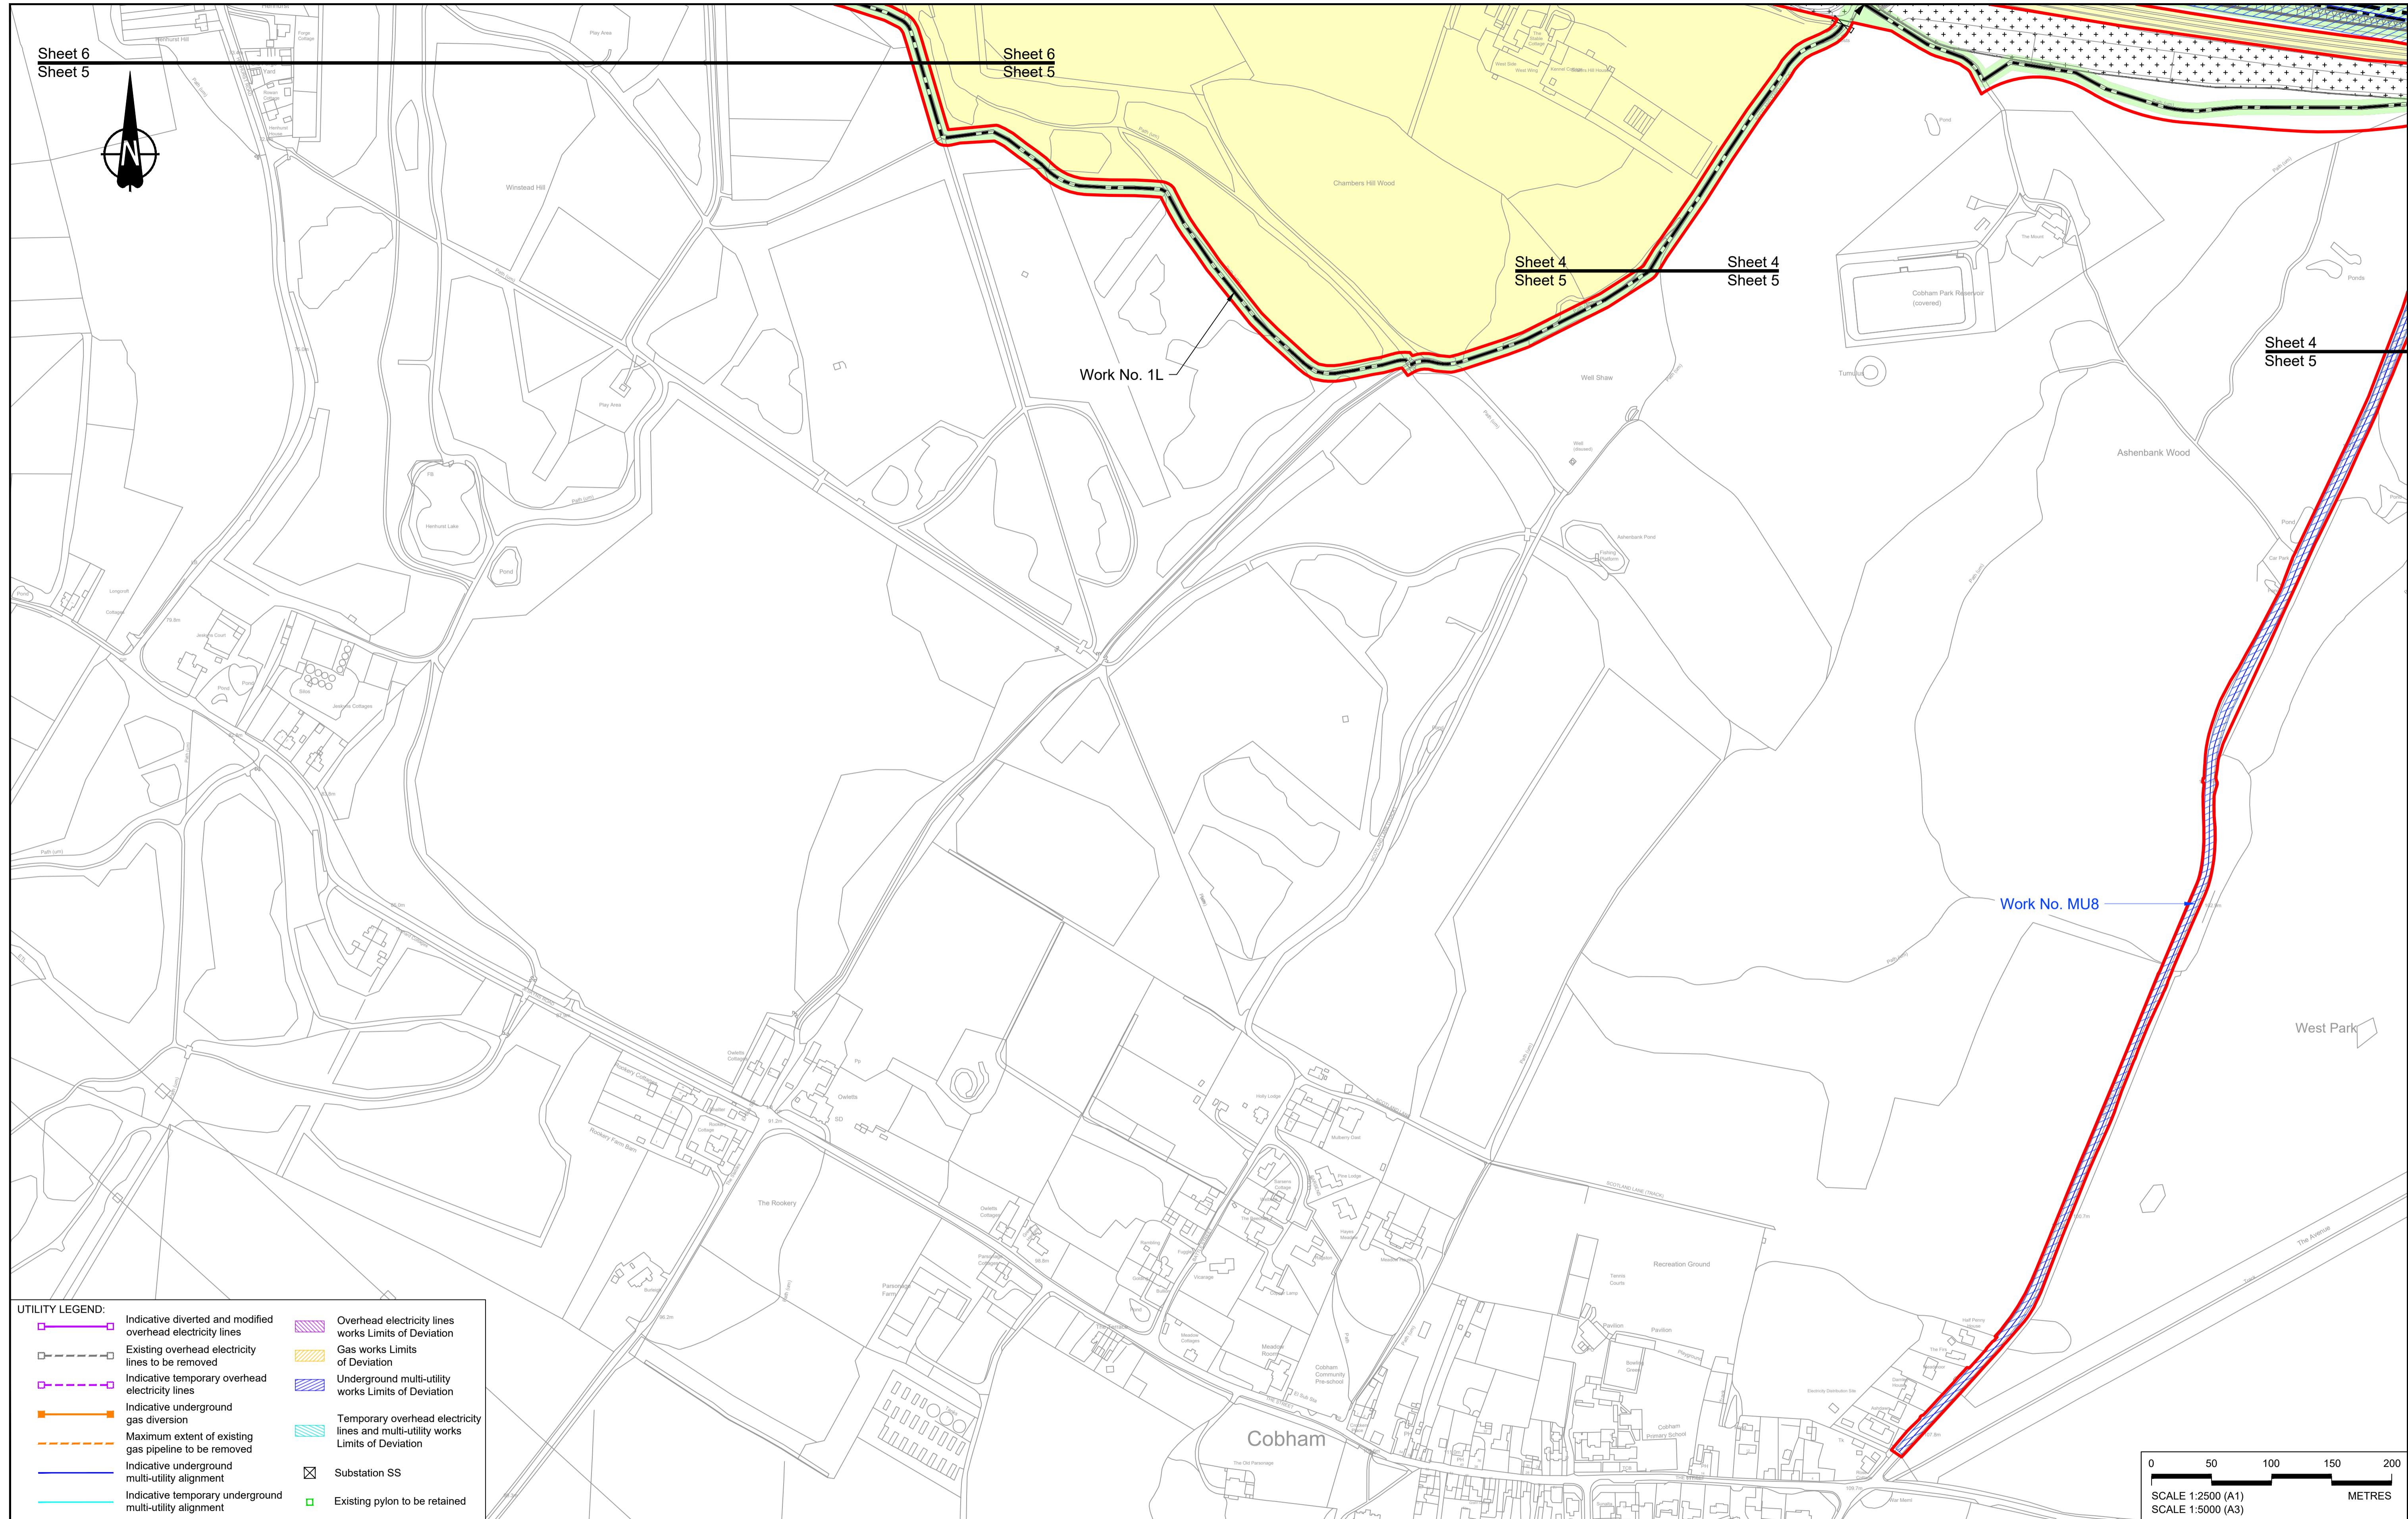
LEGEND:

Order Limits	Flood compensation area	Commencement of linear work	Ecological habitat creation and receptor site for protected species
Linear Work Centreline (including streets)	Culvert	Commencement and termination of linear work	Temporary ecological habitat
Local Authority boundary	Bridge/structure	Termination of linear work	Open space provision, replacement open space or replacement common land
Highway Work (includes structures) Limits of Deviation	Watercourse diversion work centreline	Bat Barn structure	Bat Barn structure
Area excluded from Order Limits	Infiltration basin, detention basin or retention pond boundary	Construction Area - Utilities Logistic Hub	Travellers site
	Major structure	Construction Area - Main Works Compound	Water inlet with self-regulating valve

DCO Application
Application Document Number: TR010032/APP/2.6
Scale: 1:2500

WORKS PLANS
REGULATION 5(2)(j)
SHEET 4 - COMPOSITE

Original Size: A1 | Revision: P01
Drawing title: WORKS PLANS REGULATION 5(2)(j) SHEET 4 - COMPOSITE
Drawing Number: HE540039-CJV-BOP-SZZ_GN000000_DR-CX-20002
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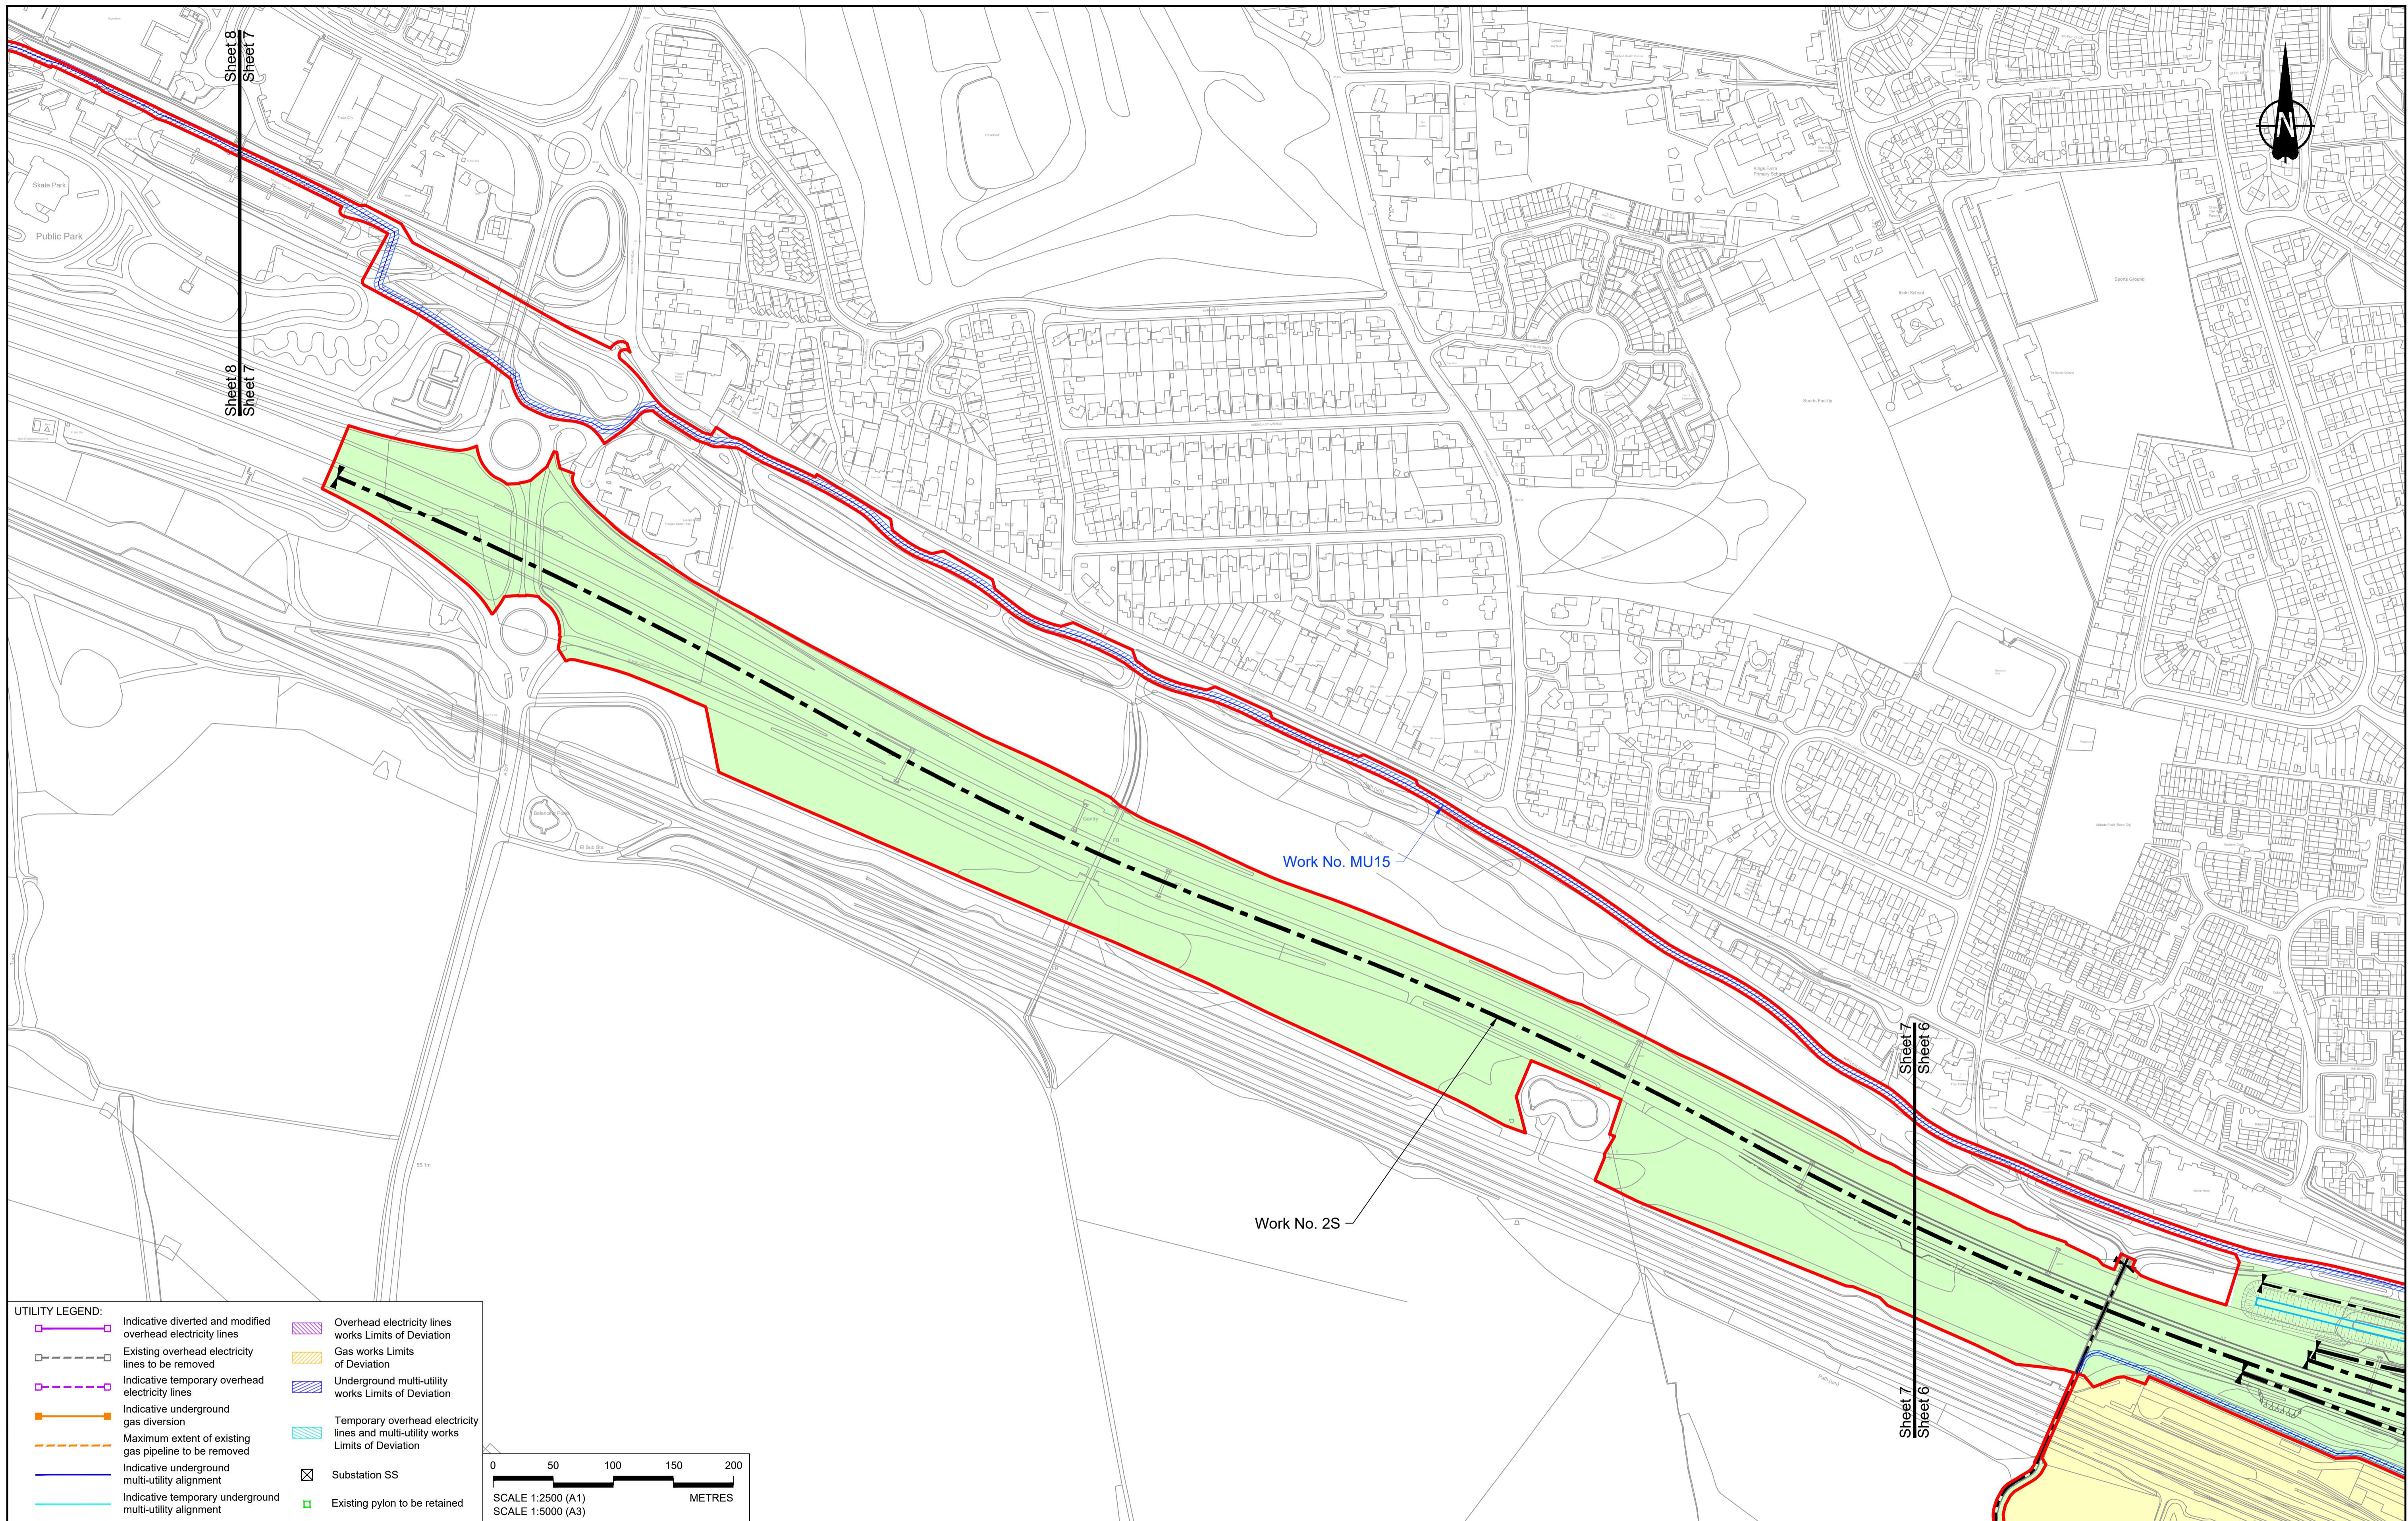
- Order Limits
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- Infiltration basin, detention basin or retention pond boundary
- Major structure
- Commencement of linear work
- Commencement and termination of linear work
- Termination of linear work
- Bat Barn structure
- Construction Area - Utilities Logistic Hub
- Construction Area - Main Works Compound
- Ecological habitat creation and receptor site for protected species
- Temporary ecological habitat
- Open space provision, replacement open space or replacement common land
- Travellers site
- Water inlet with self-regulating valve

Project:

DCO Application
Application Document Number: TR010032/APP/2.6
Scale: 1:2500
Drawing title: WORKS PLANS
REGULATION 5(2)(j)
SHEET 5 - COMPOSITE

Status:
Original Size: A1
Revision: P01
Client: national highways

Drawing Number: HE540039-CJV-BOP-SZZ_GN000000_DR-CX-20003




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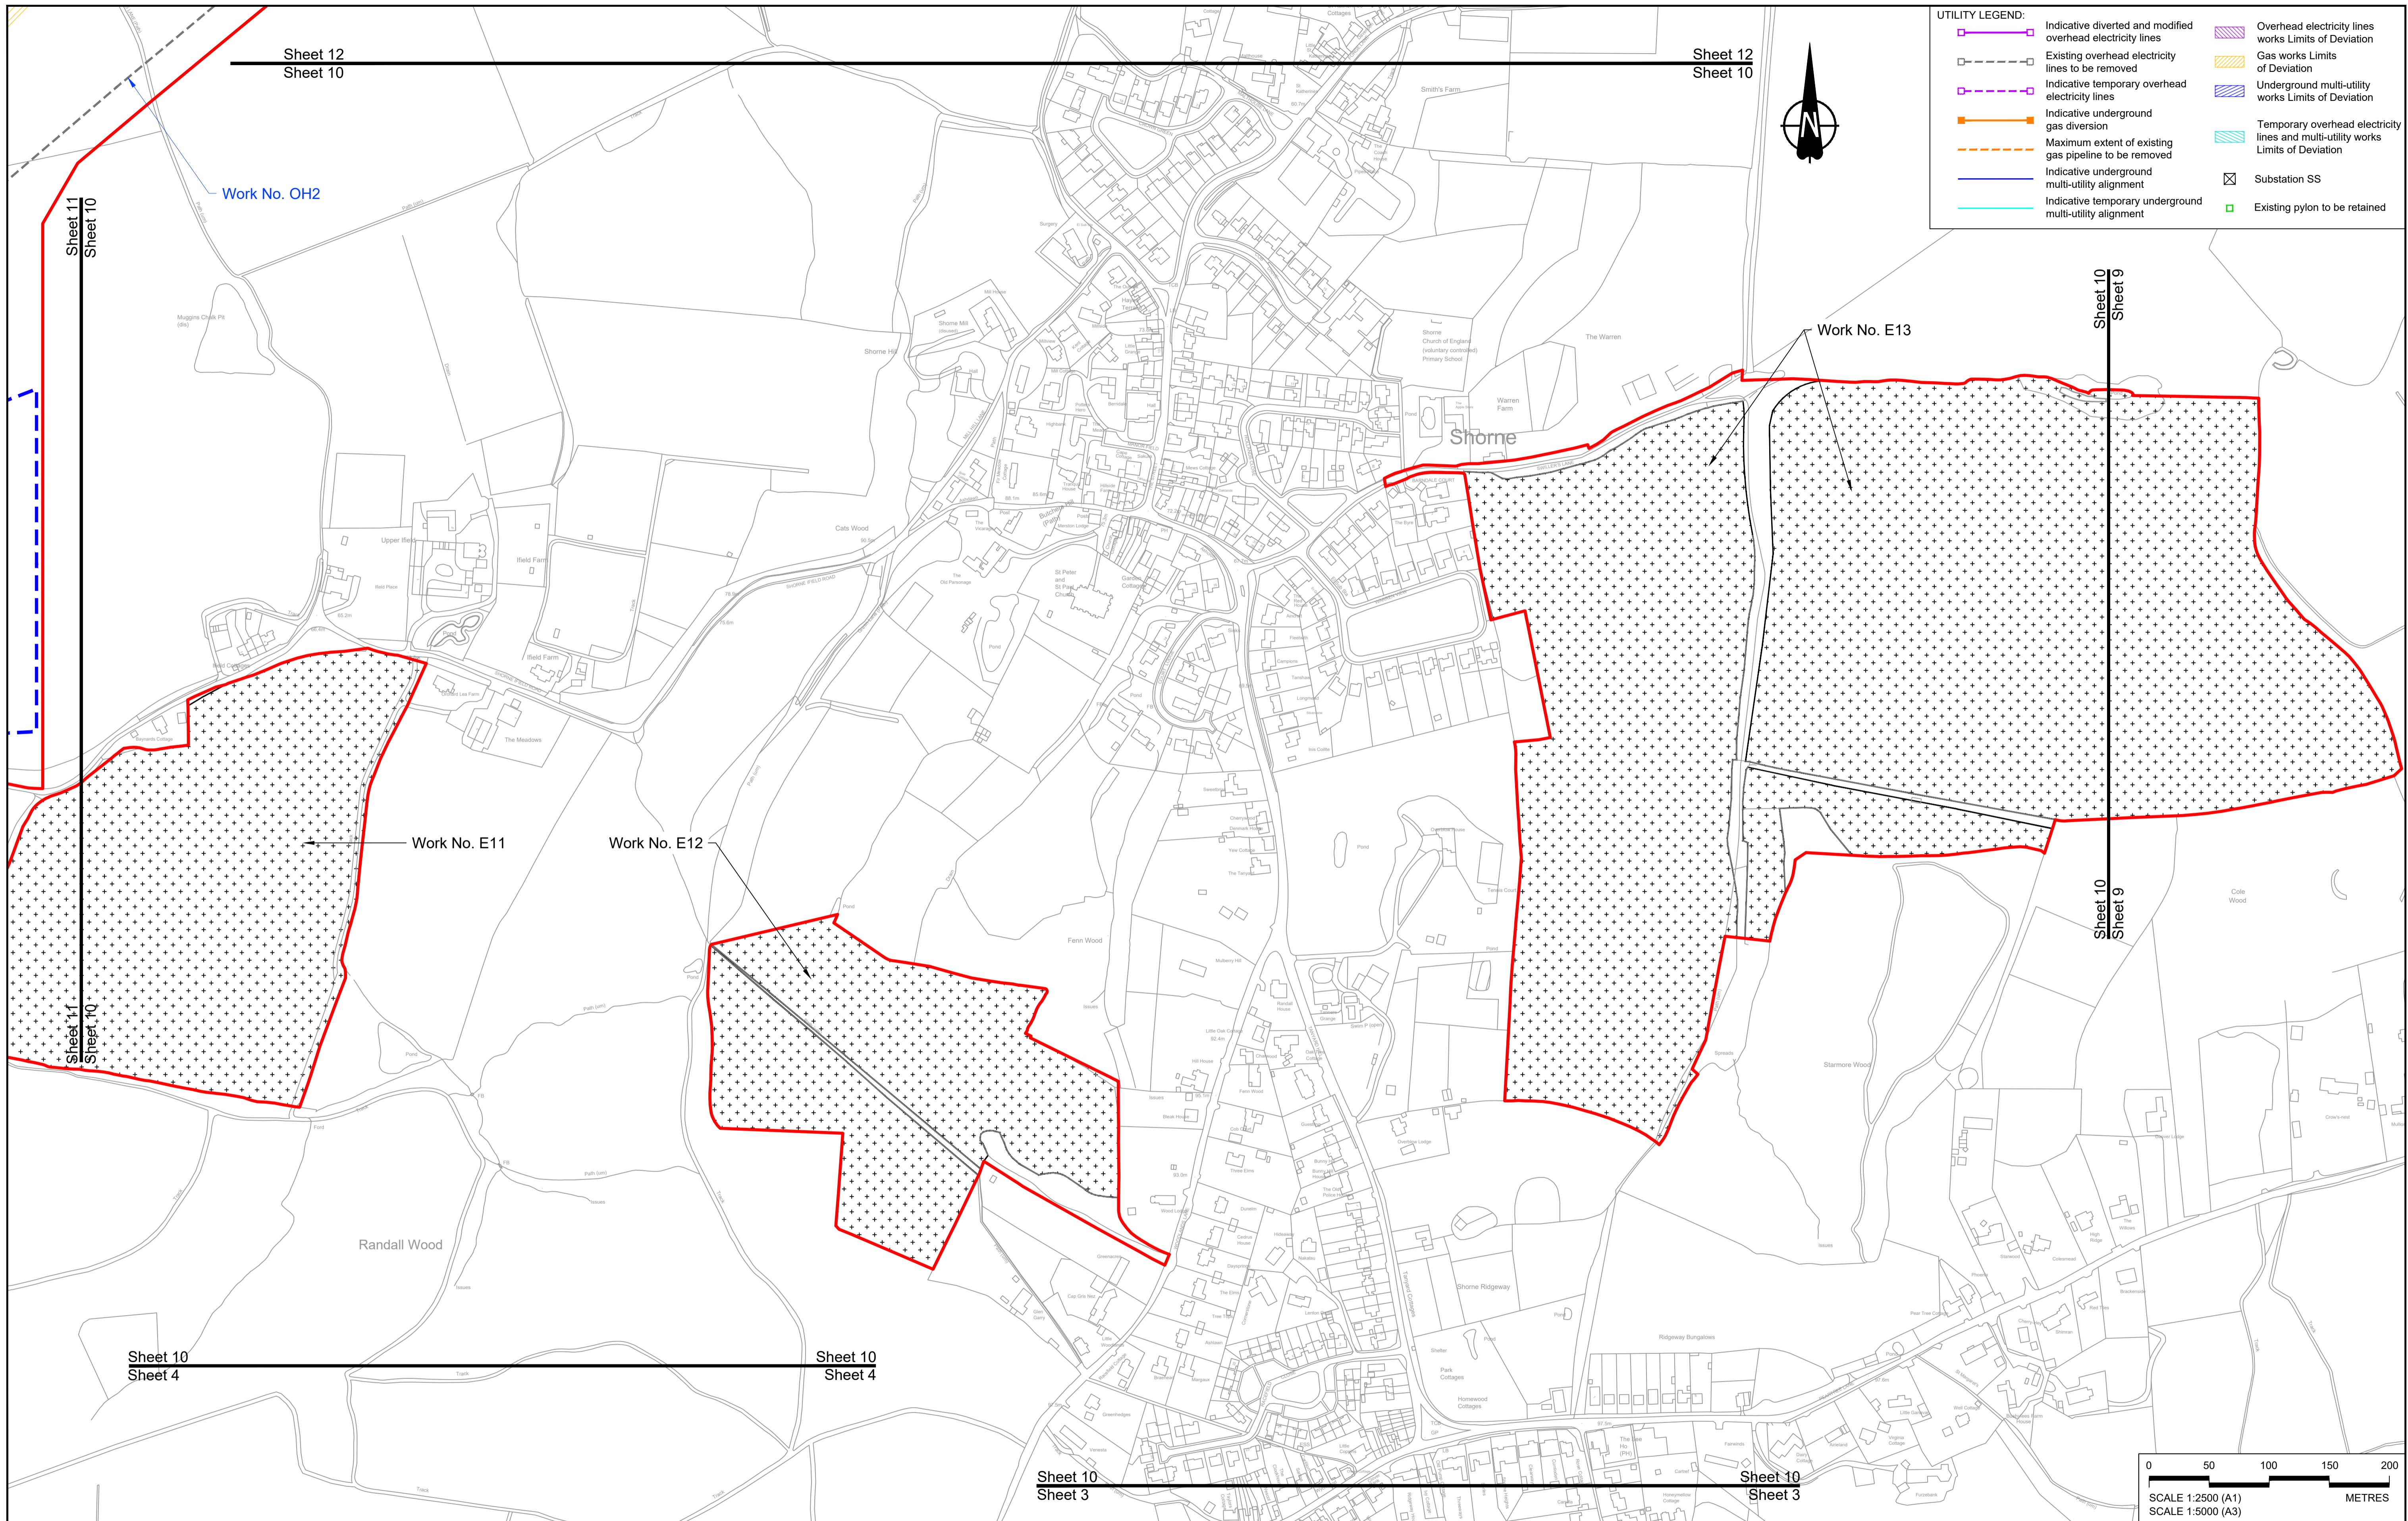
P01 S8 19/10/2022 DCO Application MS RO ASB

Rev Status Rev. Date Purpose of revision Drawn Chkd Apprv'd



HE540039-CJV-BOP-SZZ_GN000000_DR-CX-20005.dwg



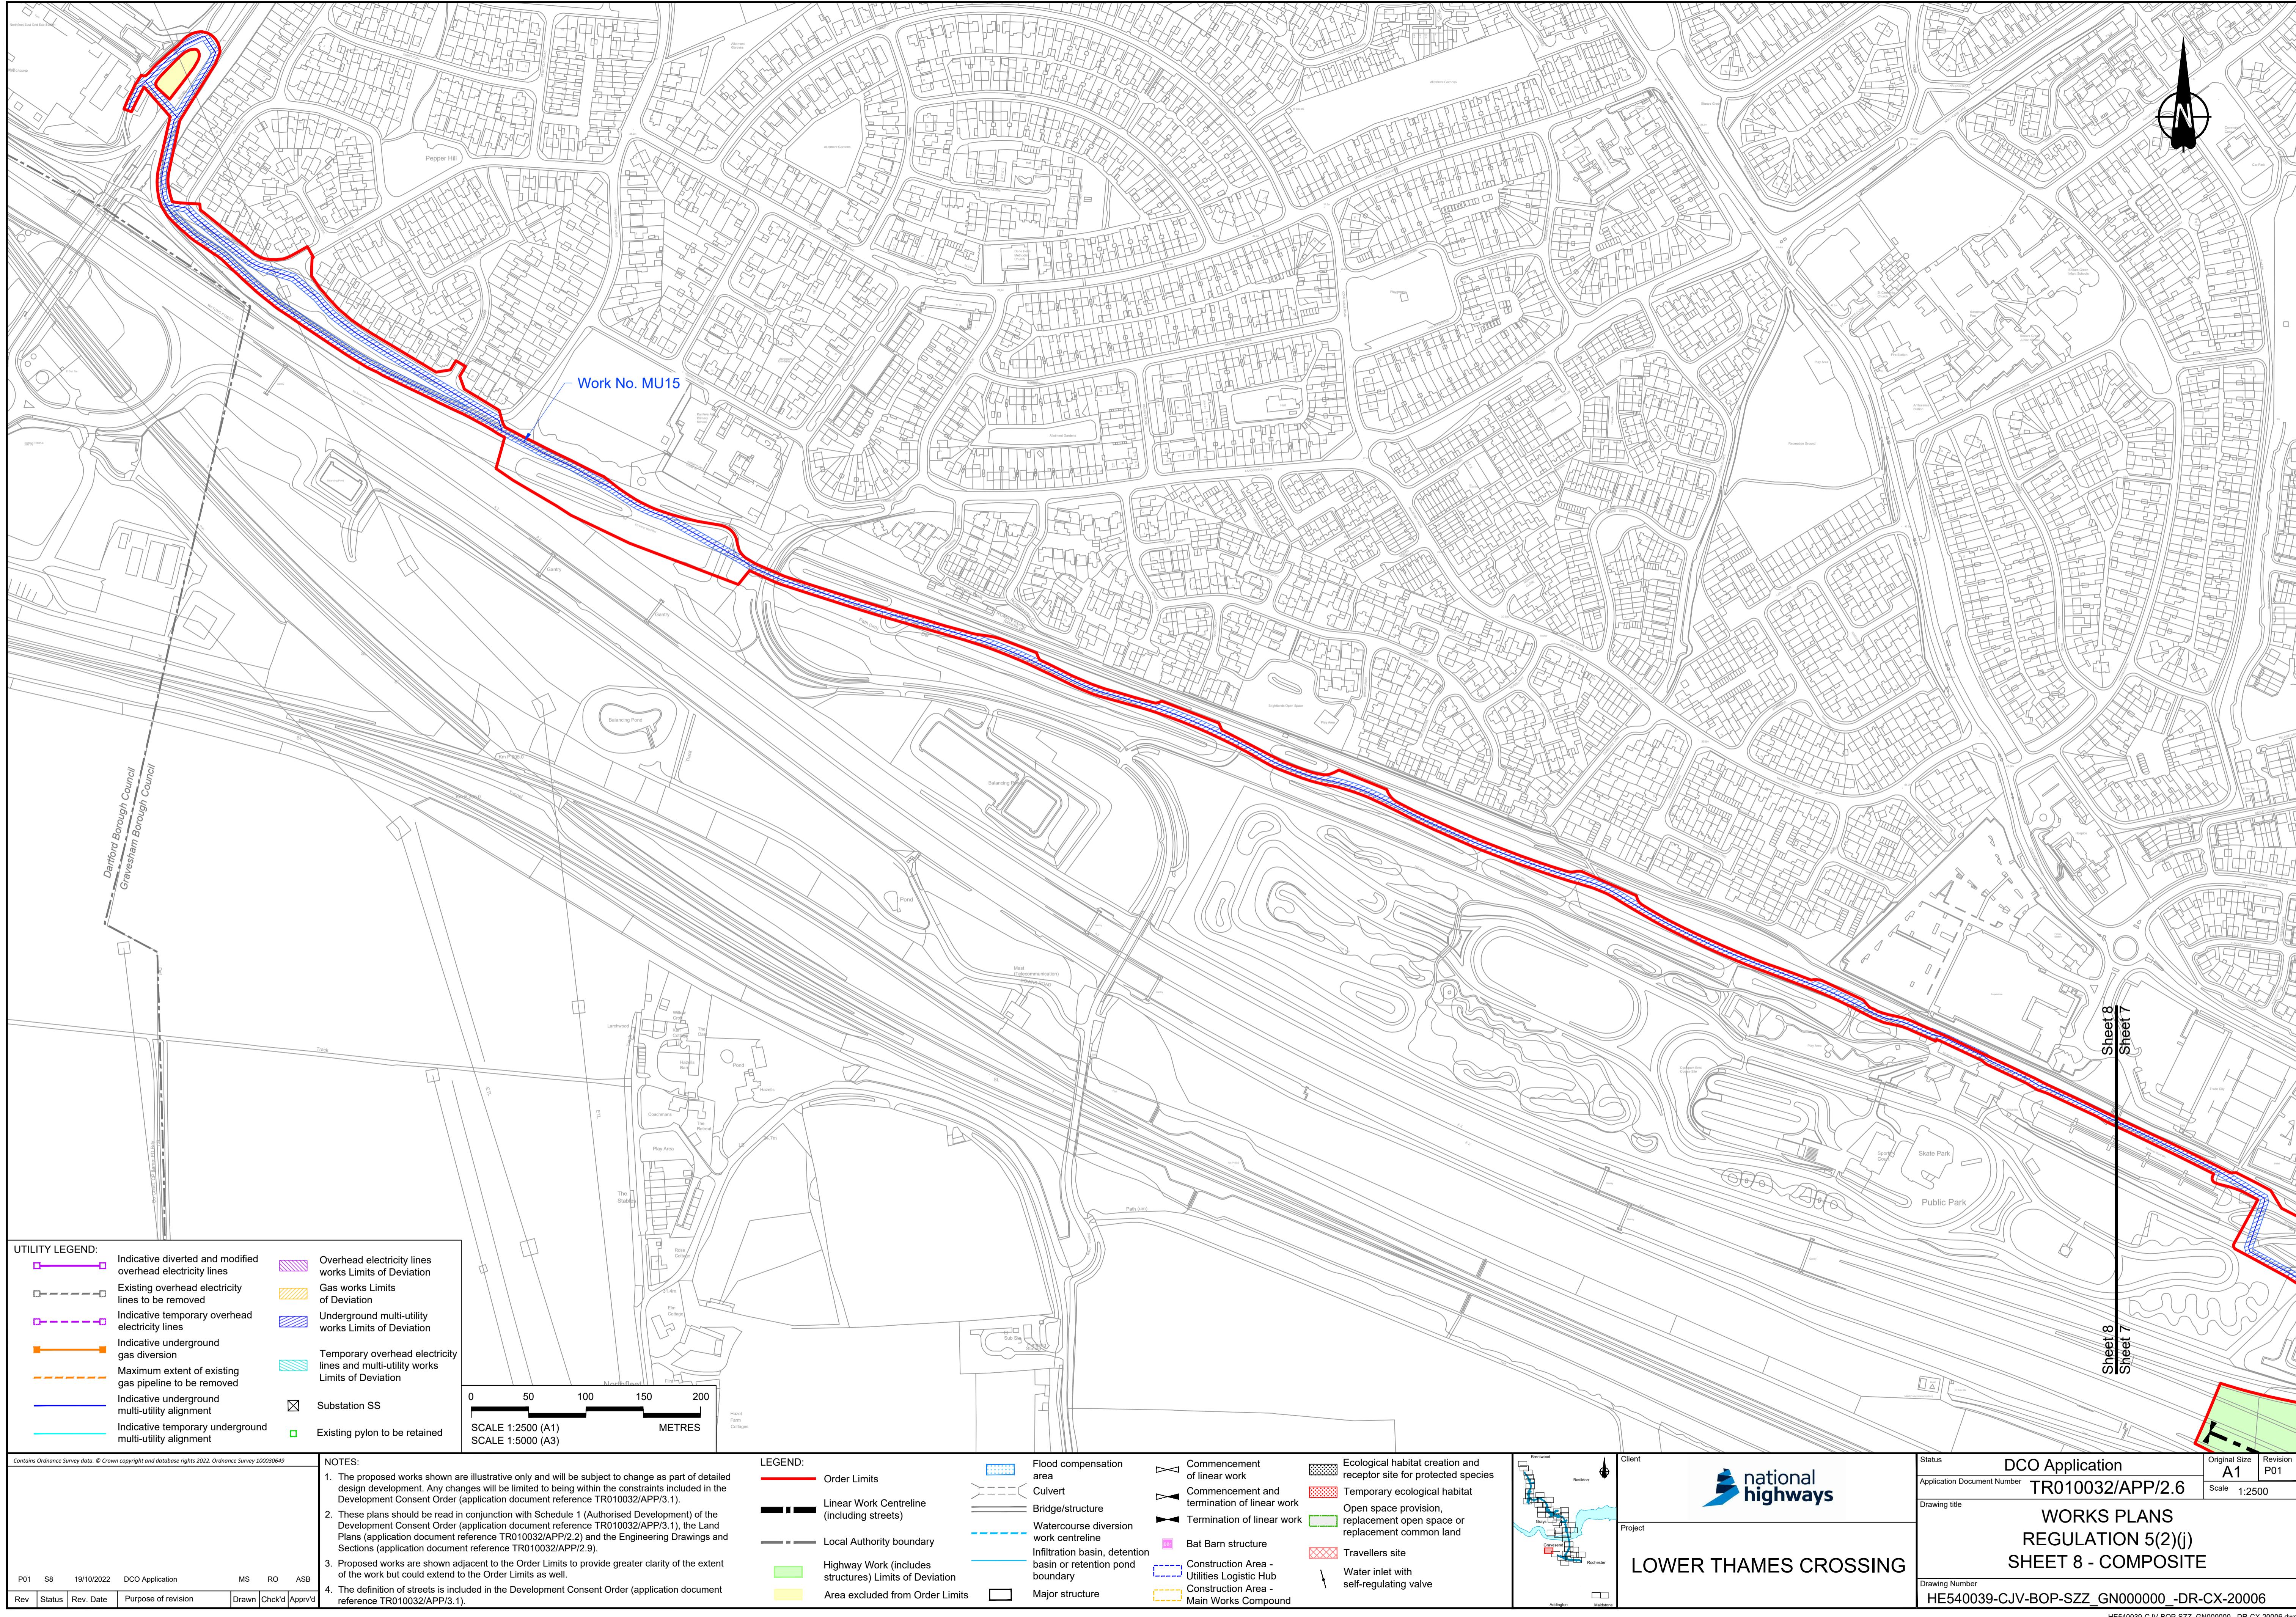


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- The definition of streets is included in the Development Consent Order (application document reference TR010032/APP/3.1).

LEGEND:

Order Limits	Flood compensation area	Commencement of linear work	Ecological habitat creation and receptor site for protected species
Linear Work Centreline (including streets)	Culvert	Commencement and termination of linear work	Temporary ecological habitat
Local Authority boundary	Bridge/structure	Termination of linear work	Open space provision, replacement open space or replacement common land
Highway Work (includes structures) Limits of Deviation	Watercourse diversion work centreline	Bat Barn structure	Bat Barn structure
Highway Work (includes structures) Limits of Deviation	Infiltration basin, detention basin or retention pond boundary	Construction Area - Utilities Logistic Hub	Travellers site
Area excluded from Order Limits	Major structure	Construction Area - Main Works Compound	Water inlet with self-regulating valve




Client

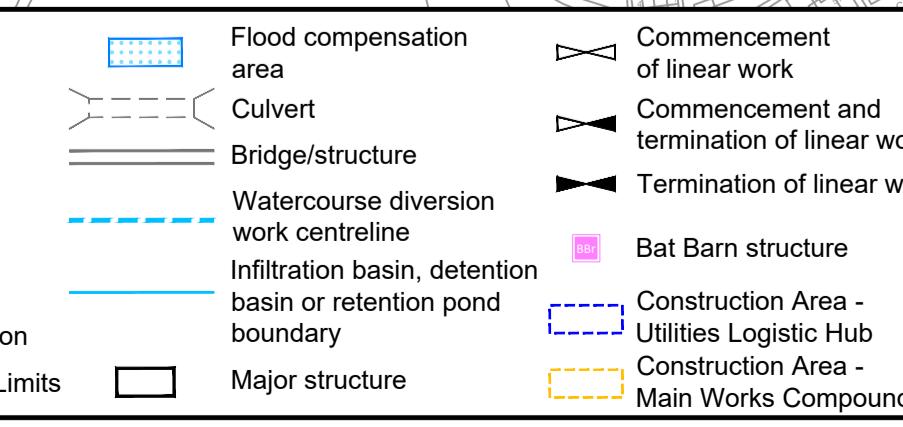

DCO Application
Application Document Number: TR010032/APP/2.6
Original Size: A1
Revision: P01
Scale: 1:2500
WORKS PLANS
REGULATION 5(2)(j)
SHEET 10 - COMPOSITE

Drawing Number: HE540039-CJV-BOP-SZZ_GN0000000_DR-CX-20008

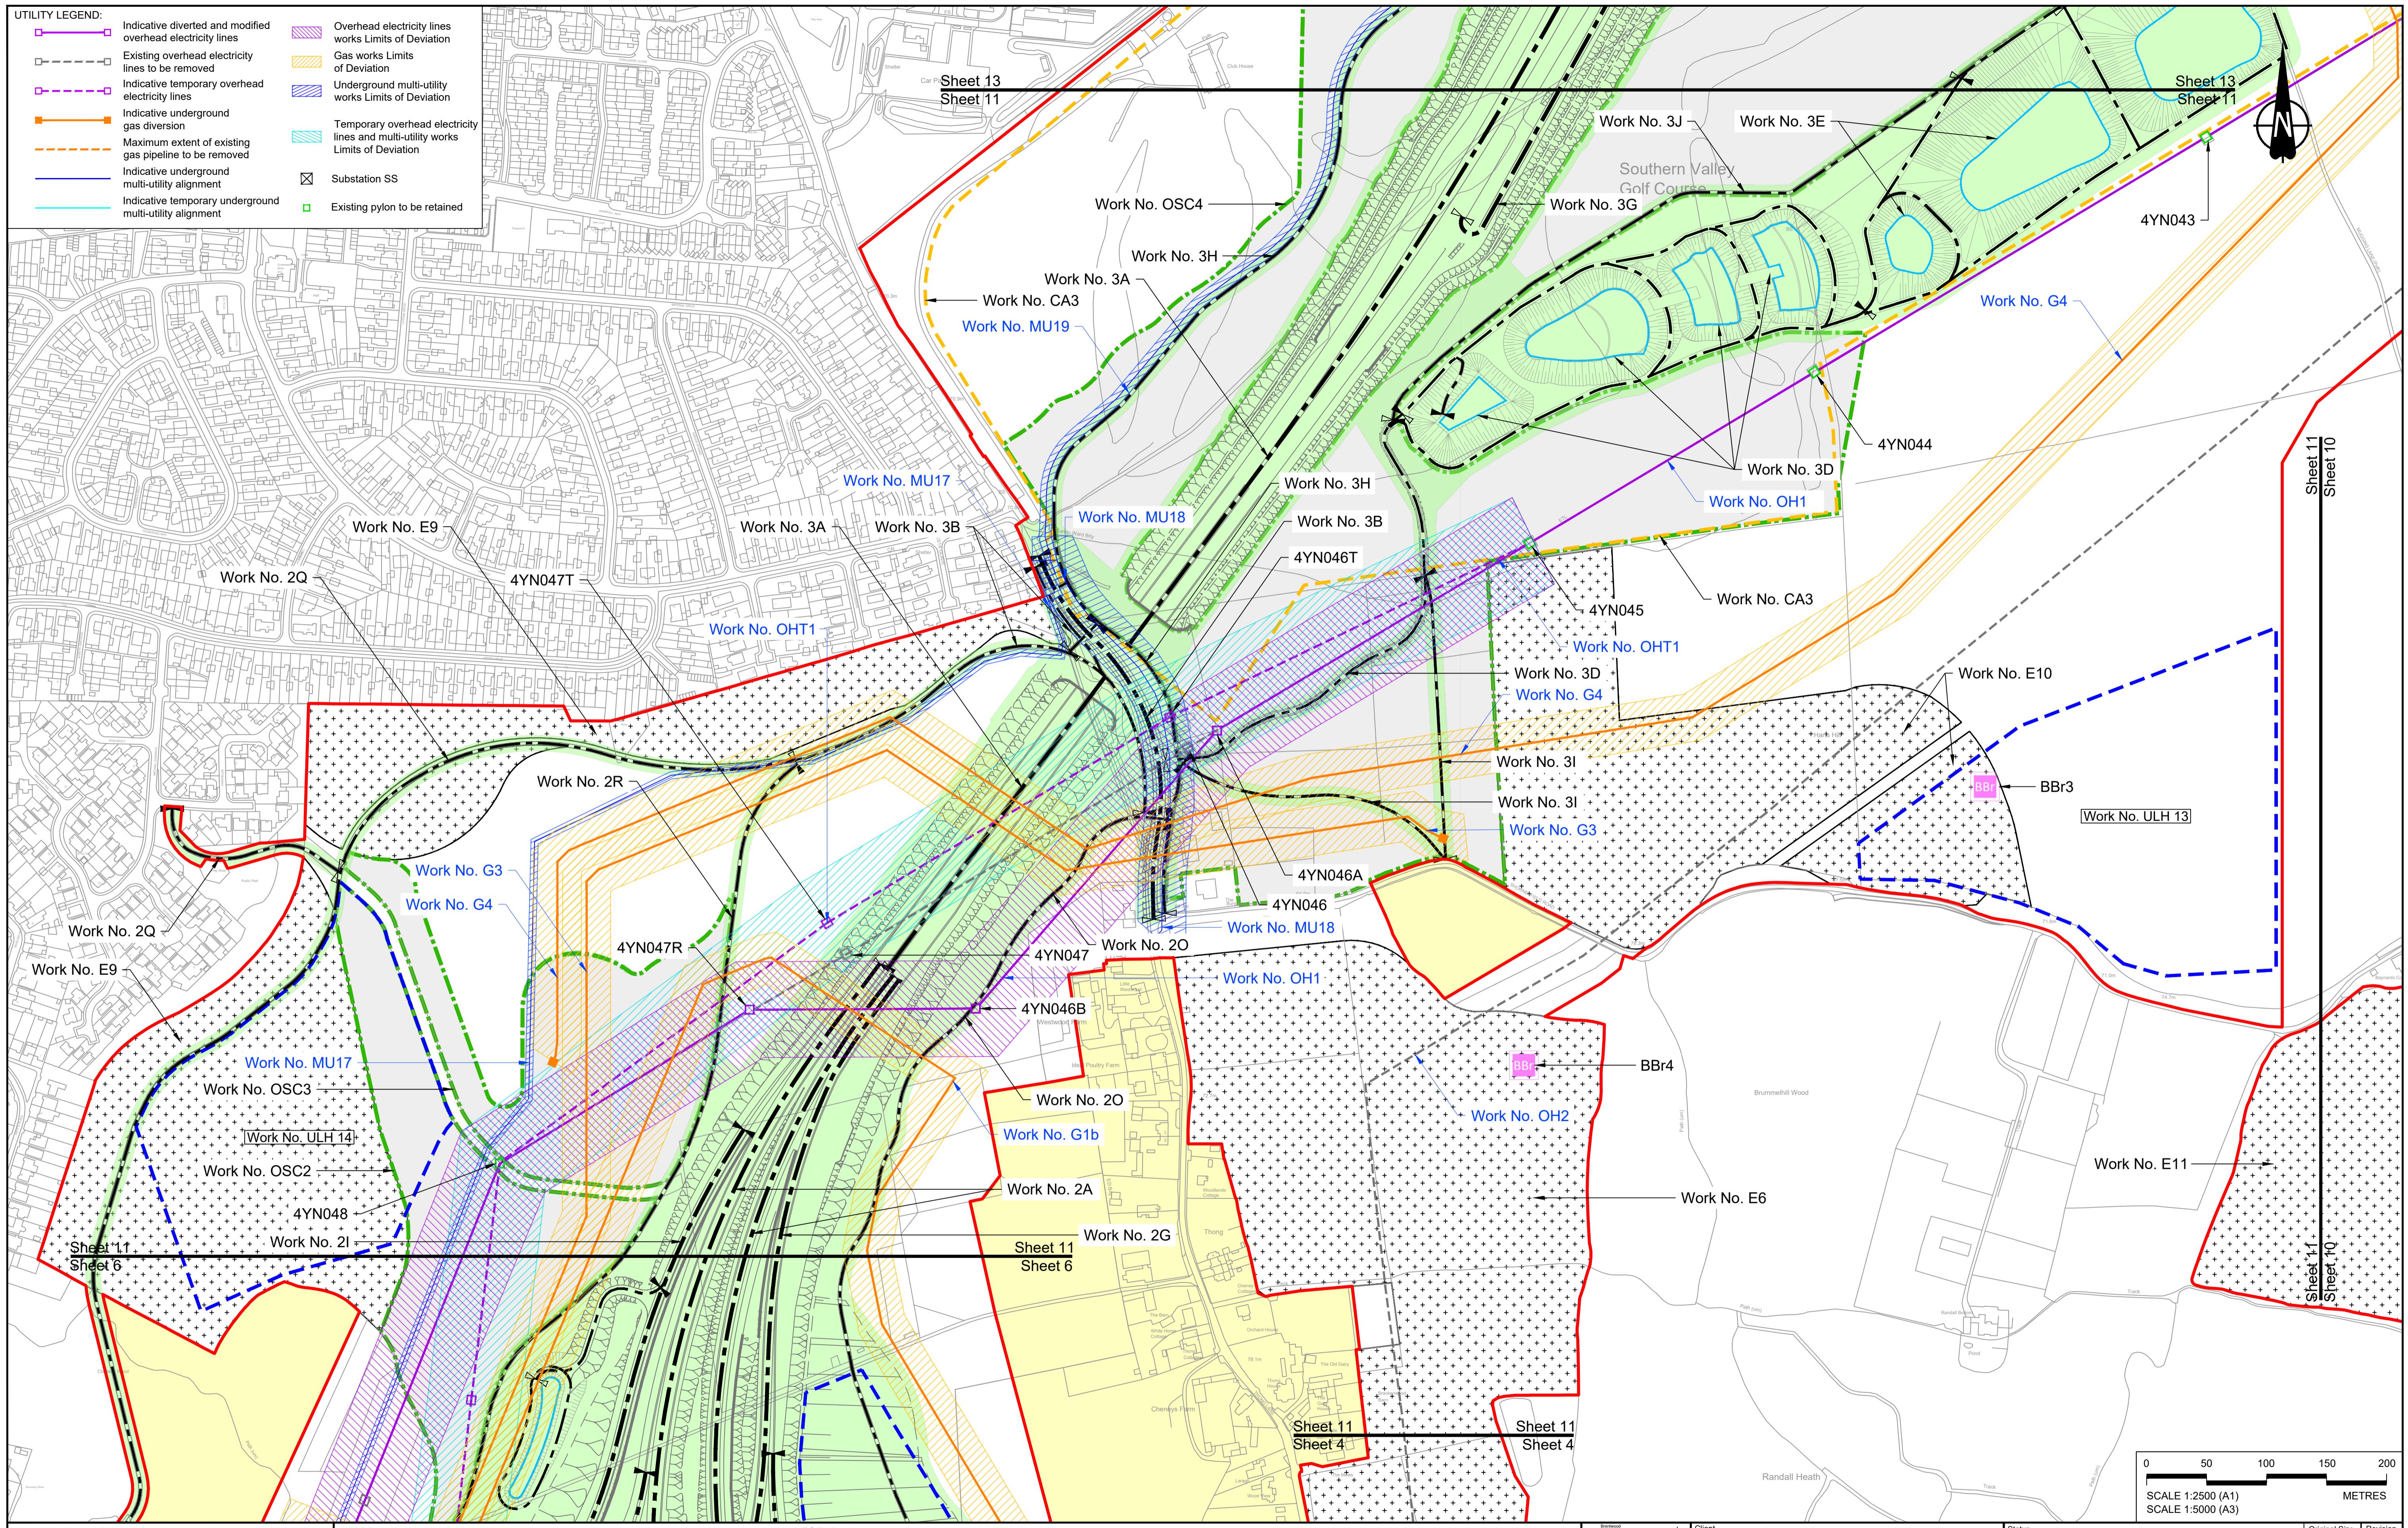

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LEGEND:

- Order Limits
- Linear Work Centreline (including streets)
- Local Authority boundary
- Highway Work (includes structures) Limits of Deviation
- Area excluded from Order Limits
- Flood compensation area
- Culvert
- Bridge/structure
- Watercourse diversion work centreline
- Infiltration basin, detention basin or retention pond boundary
- Major structure
- Commencement of linear work
- Commencement and termination of linear work
- Termination of linear work
- Ecological habitat creation and receptor site for protected species
- Temporary ecological habitat
- Open space provision, replacement open space or replacement common land
- Bat Barn structure
- Construction Area - Utilities Logistic Hub
- Construction Area - Main Works Compound
- Travellers site
- Water inlet with self-regulating valve

Client: national highways

Status: DCO Application
Original Size: A1
Revision: P01

Application Document Number: TR010032/APP/2.6
Scale: 1:2500

Drawing title:


WORKS PLANS
REGULATION 5(2)(j)
SHEET 11 - COMPOSITE

Project:

Drawing Number:

HE540039-CJV-BOP-SZZ_GN000000_D-R-CX-20009

HE540039-CJV-BOP-SZZ_GN000000_D-R-CX-20009.dwg

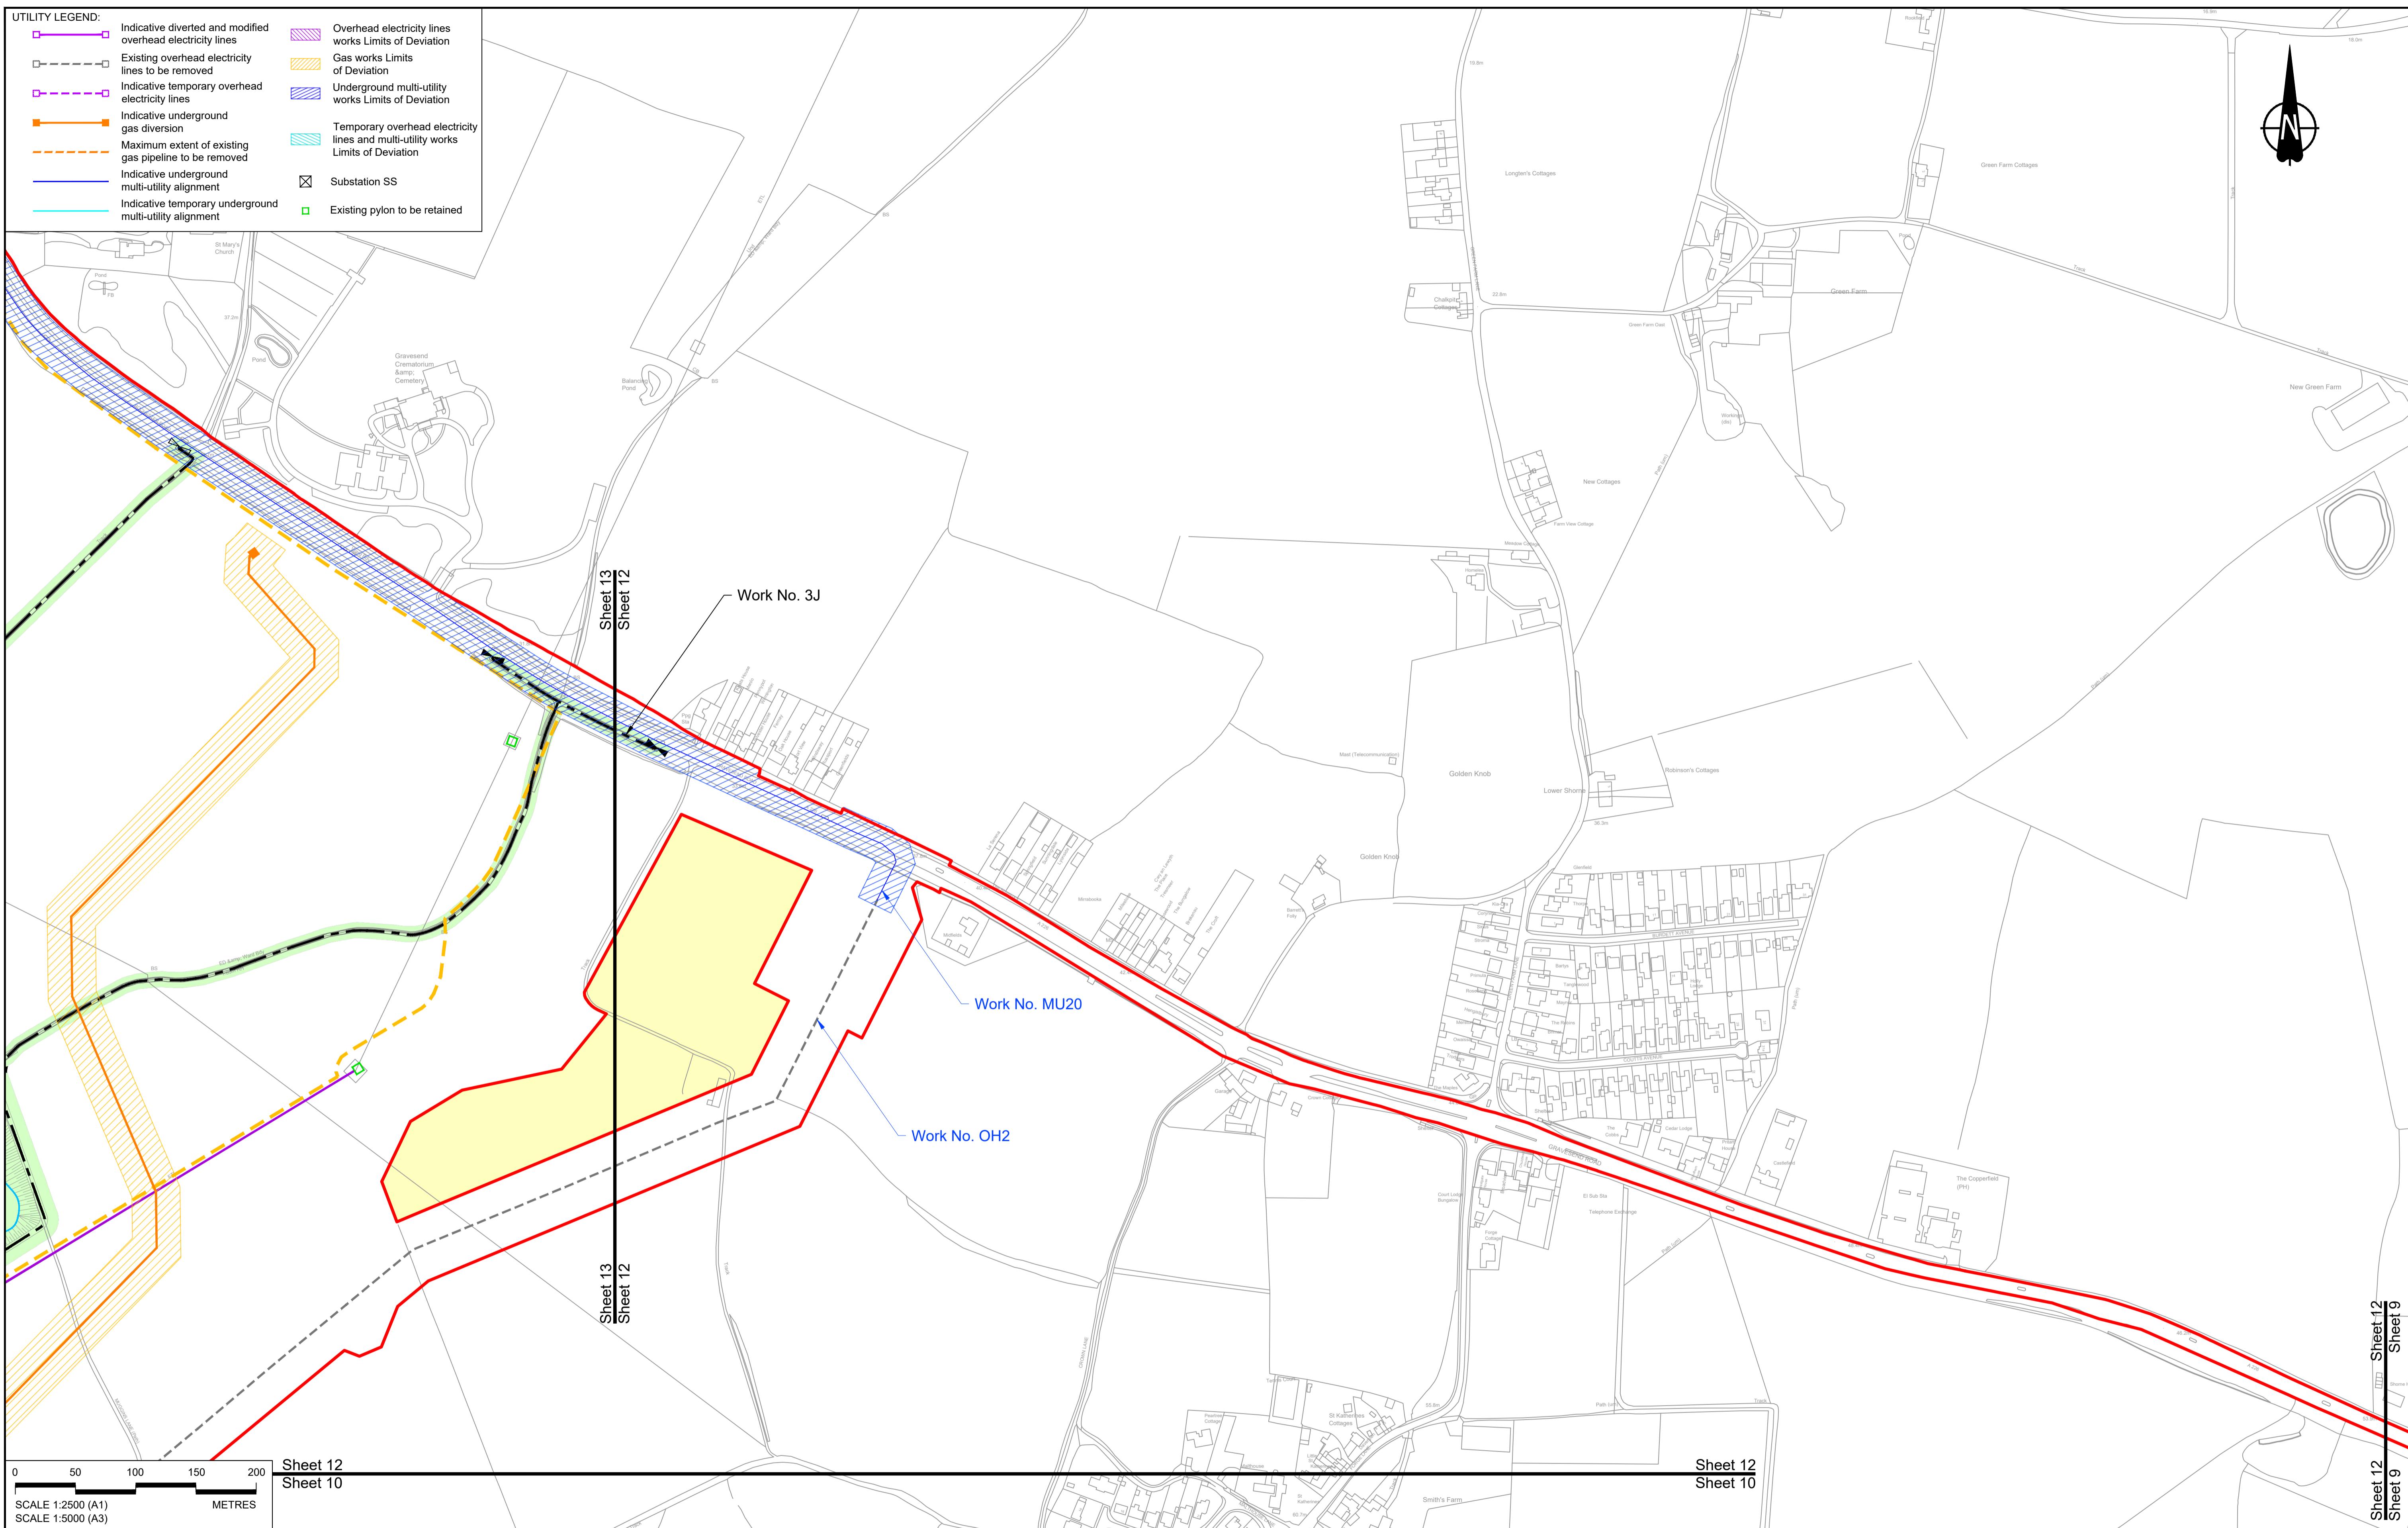

P01	S8	19/10/2022	DCO Application	MS	RO	ASB
Rev	Status	Rev. Date	Purpose of revision	Drawn	Chk'd	Apprv'd


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LEGEND:


- Order Limits:** Red line
- Linear Work Centreline (including streets):** Black line
- Local Authority boundary:** Dashed line
- Highway Work (includes structures) Limits of Deviation:** Green line
- Flood compensation area:** Blue dotted line
- Culvert:** Line with arrows
- Bridge/structure:** Solid line
- Watercourse diversion work centreline:** Dashed line
- Infiltration basin, detention basin or retention pond boundary:** Blue dashed line
- Bat Barn structure:** Pink square
- Construction Area - Utilities Logistic Hub:** Blue dashed line
- Construction Area - Main Works Compound:** Yellow dashed line
- Ecological habitat creation and receptor site for protected species:** Grey dotted line
- Temporary ecological habitat:** Red dotted line
- Open space provision, replacement open space or replacement common land:** Green dotted line
- Travellers site:** Orange dotted line
- Water inlet with self-regulating valve:** Blue line with valve symbol
- Major structure:** White box



Client: national highways

Project: LOWER THAMES CROSSING

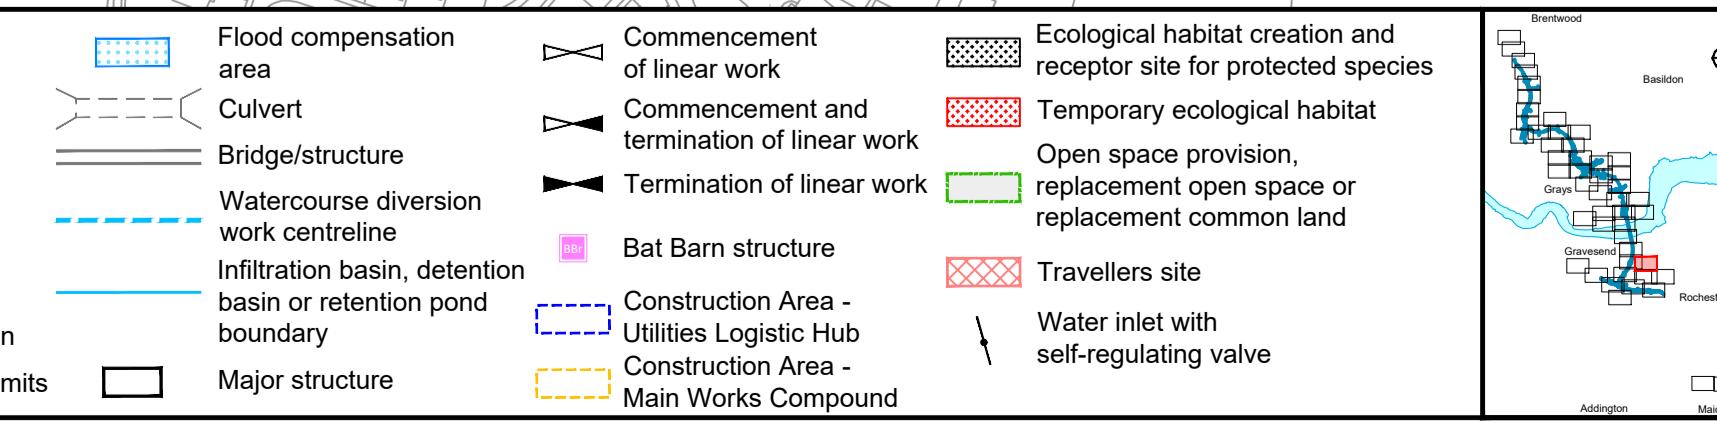Status	DCO Application	Original Size	Revision
	Application Document Number	A1	P01
	TR010032/APP/2.6		
	Drawing title	1:2500	
	WORKS PLANS		
	REGULATION 5(2)(j)		
	SHEET 12 - COMPOSITE		
	Drawing Number		
	HE540039-CJV-BOP-SZZ_GN000000_DR-CX-20057		

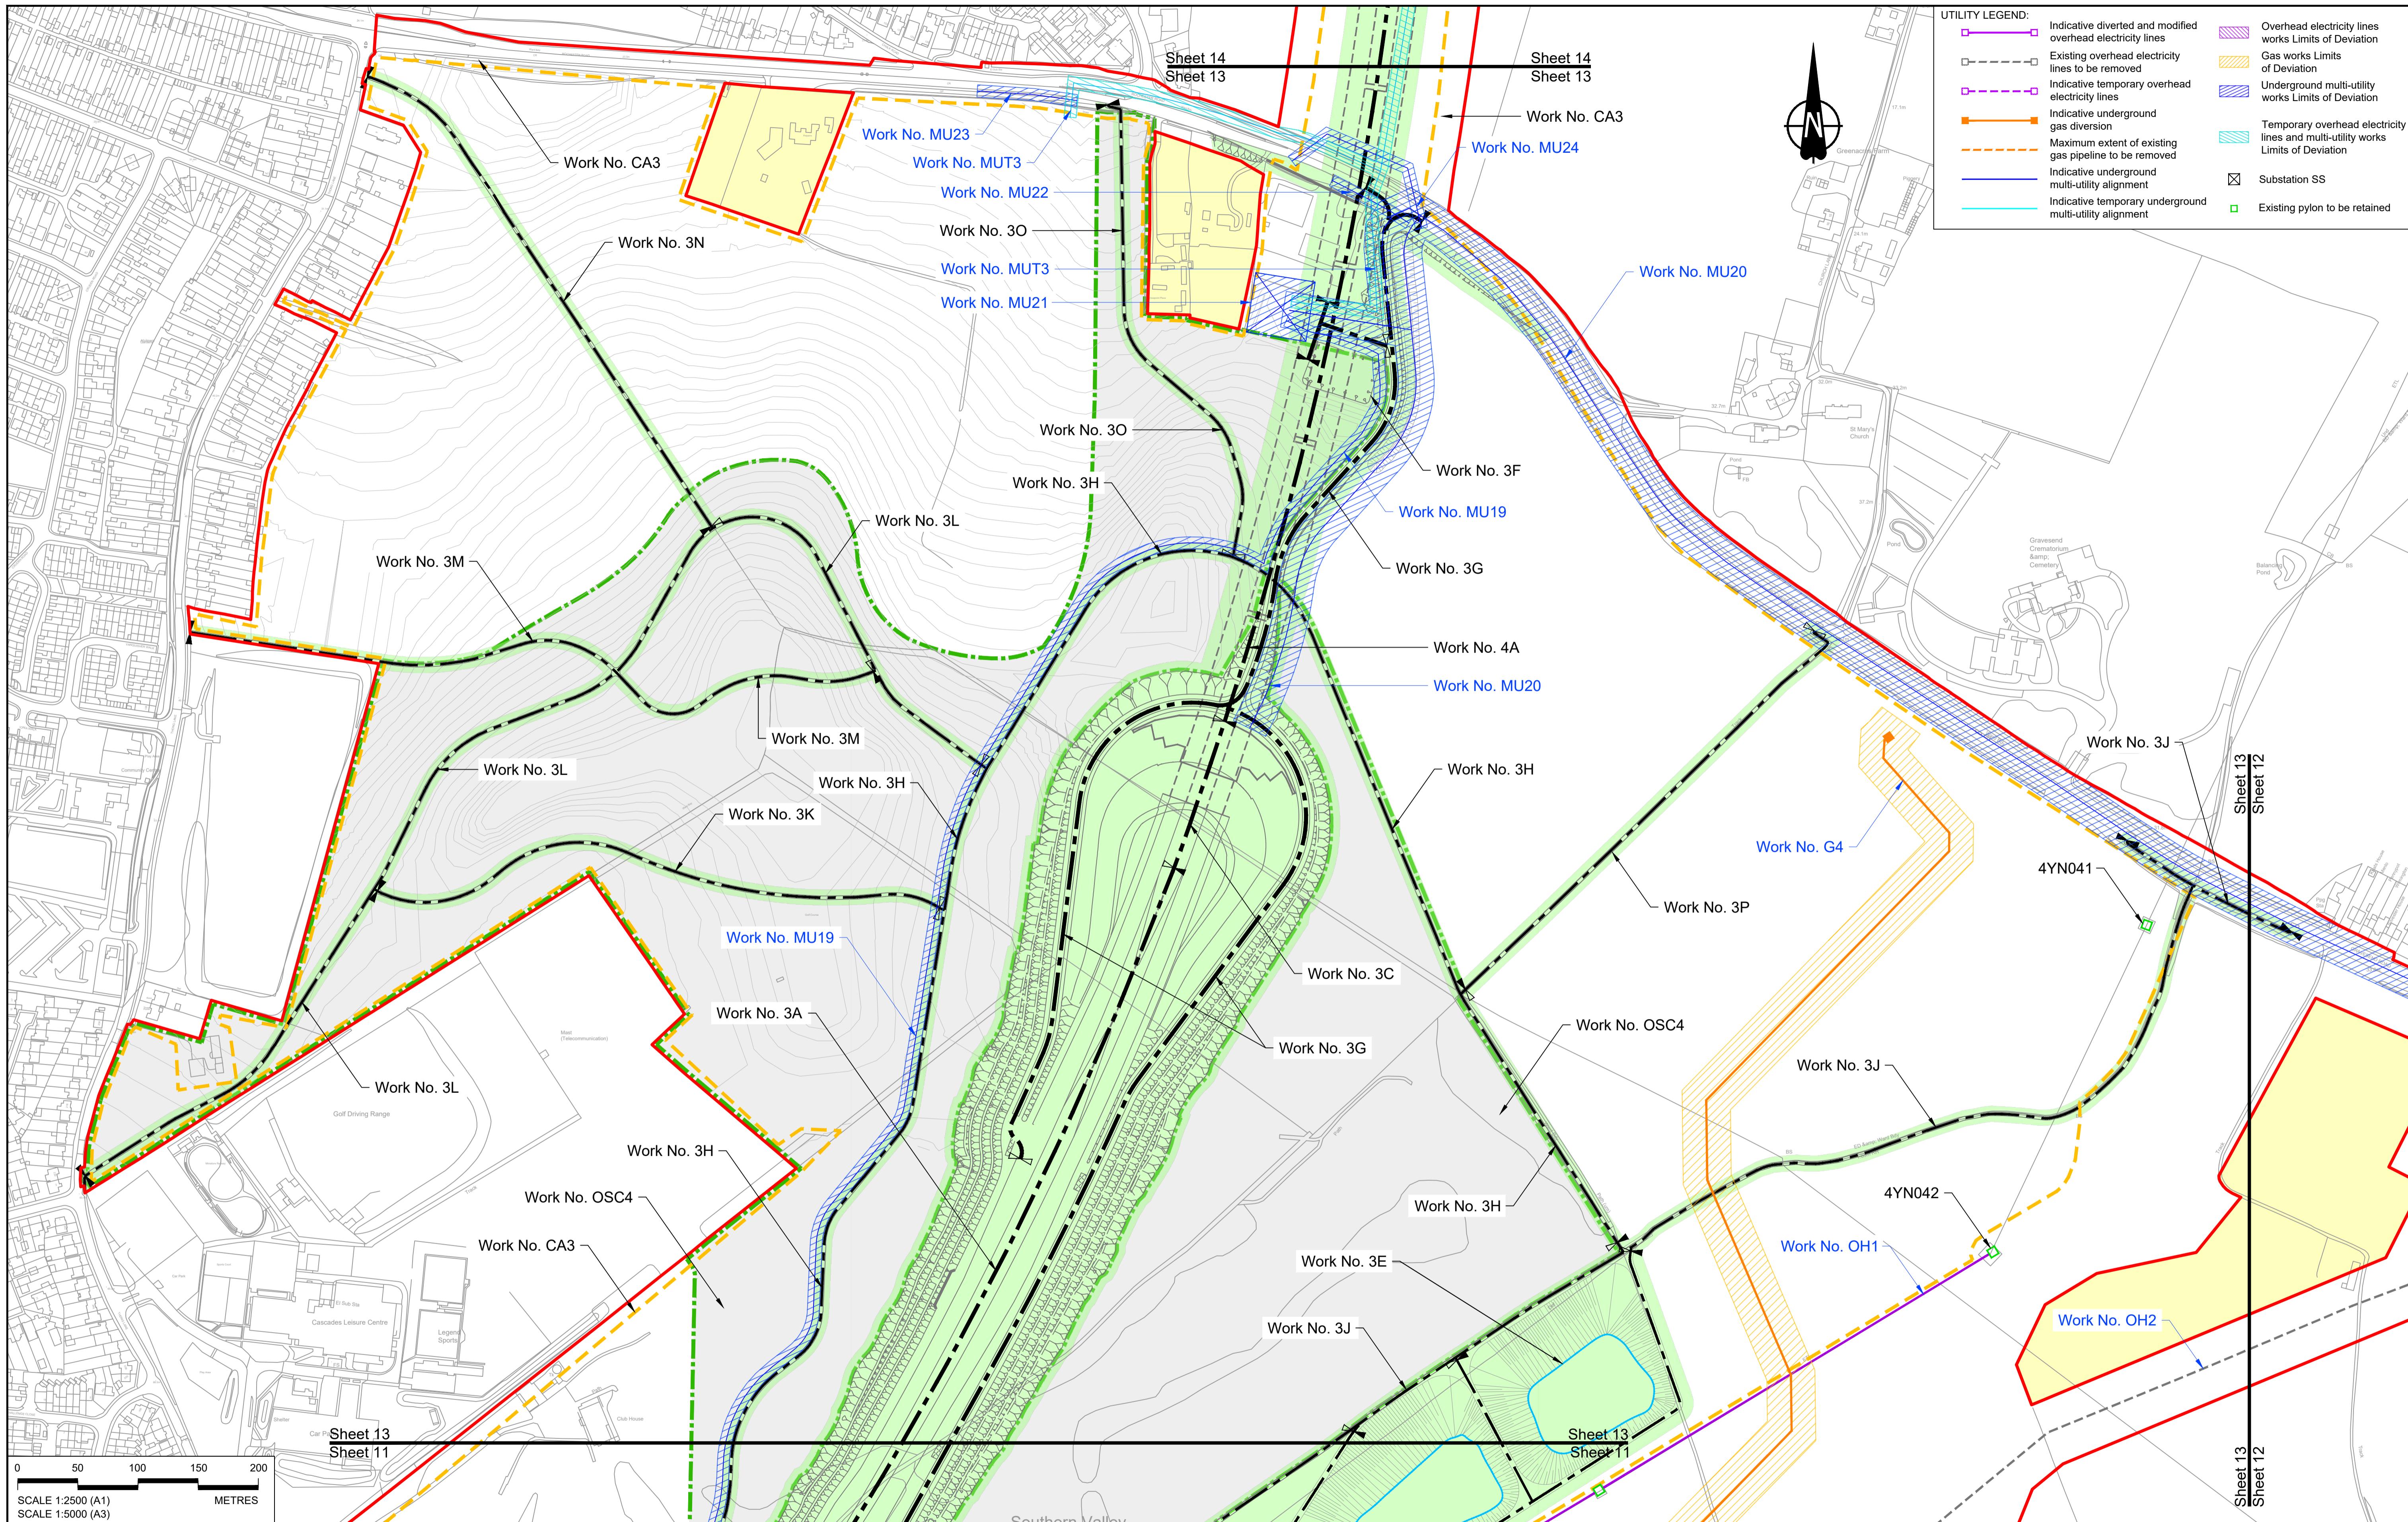


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LEGEND:

Order Limits	Flood compensation area	Commencement of linear work	Ecological habitat creation and receptor site for protected species
Linear Work Centreline (including streets)	Culvert	Commencement and termination of linear work	Temporary ecological habitat
Local Authority boundary	Bridge/structure	Termination of linear work	Open space provision, replacement open space or replacement common land
Highway Work (includes structures) Limits of Deviation	Watercourse diversion work centreline	Bat Barn structure	Travellers site
	Infiltration basin, detention basin or retention pond boundary	Construction Area - Utilities Logistic Hub	Water inlet with self-regulating valve
	Major structure	Construction Area - Main Works Compound	




Client
national highways

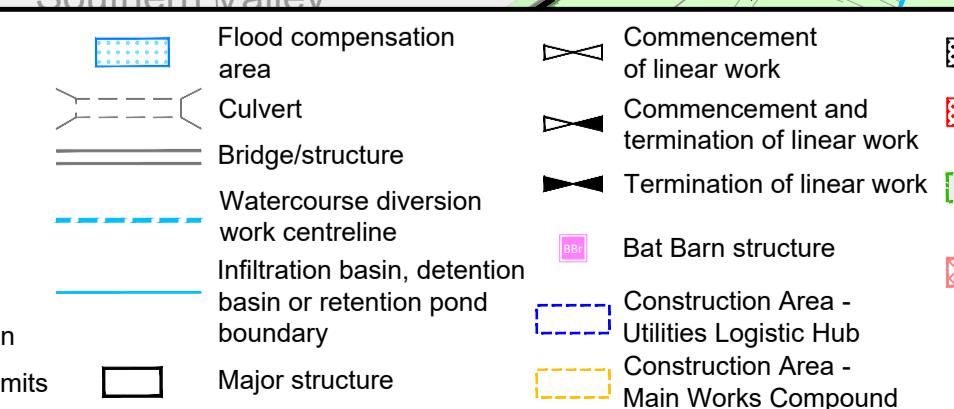Project

Status
DCO Application
Application Document Number TR010032/APP/2.6
Scale 1:2500
Drawing title
WORKS PLANS
REGULATION 5(2)(j)
SHEET 13 - COMPOSITE
Drawing Number HE540039-CJV-BOP-SZZ_GN000000_DR-CX-20010

Original Size A1 Revision P01
Scale 1:2500
Drawing title
WORKS PLANS
REGULATION 5(2)(j)
SHEET 13 - COMPOSITE
Drawing Number HE540039-CJV-BOP-SZZ_GN000000_DR-CX-20010

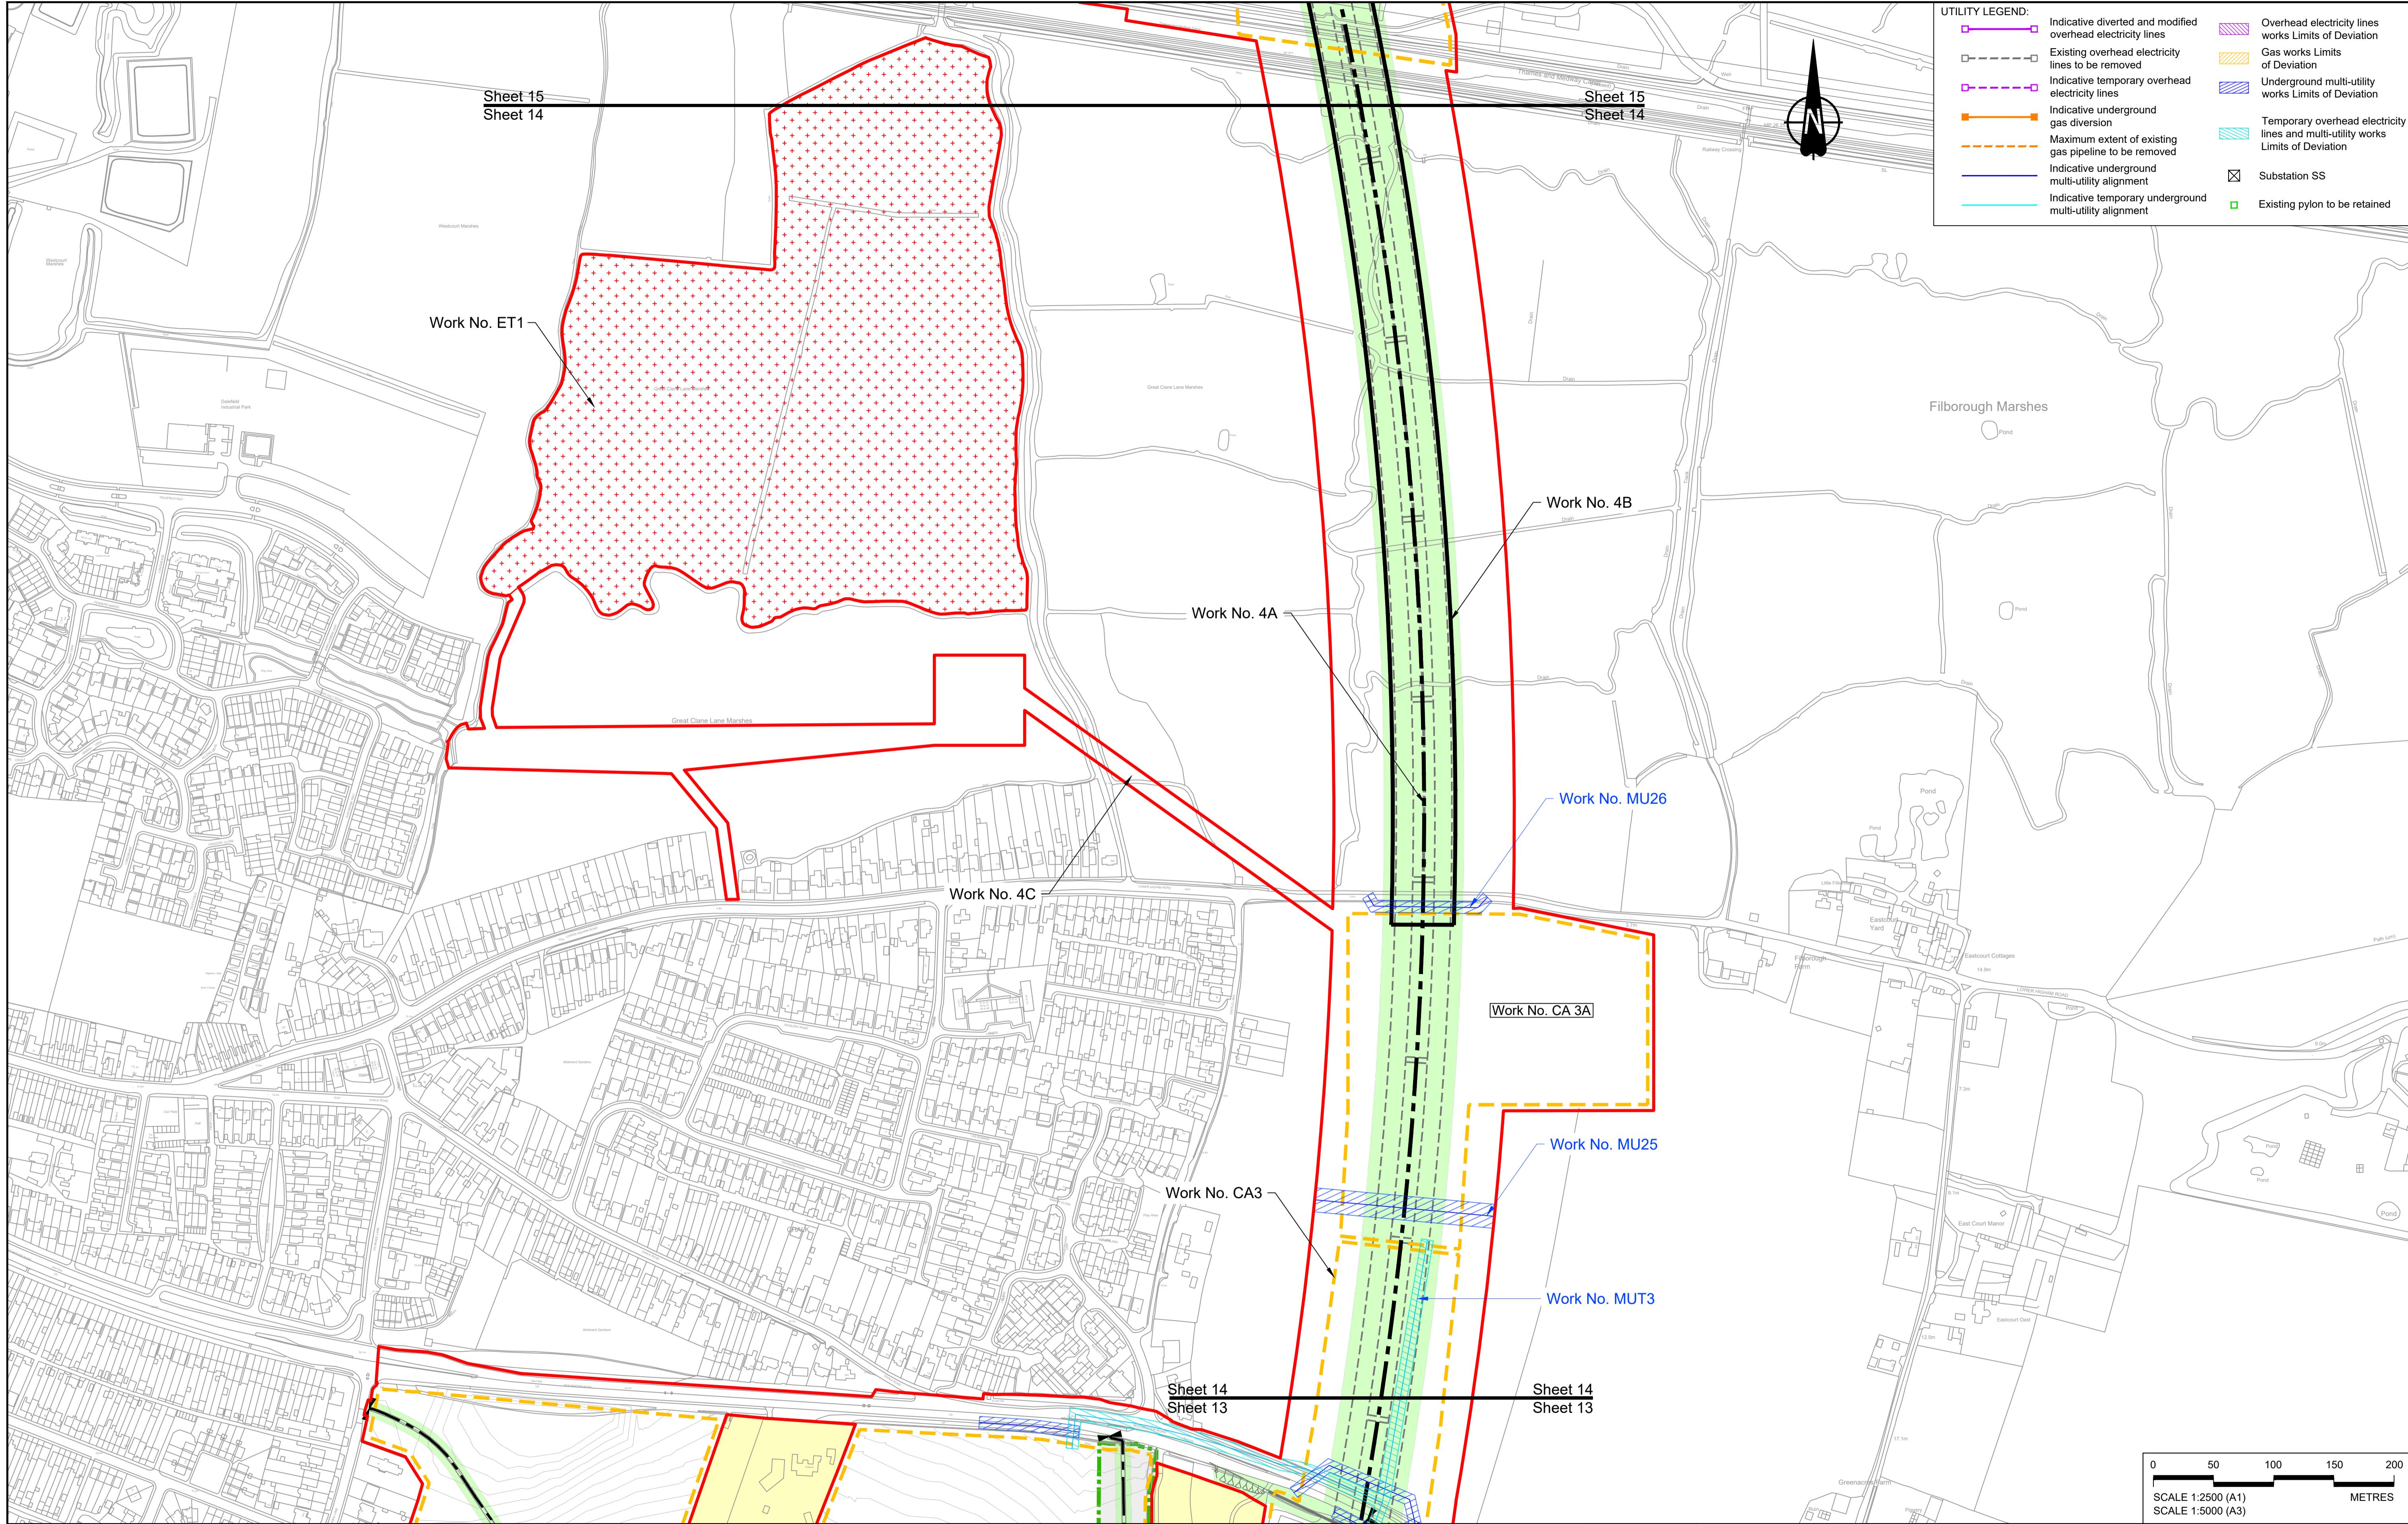

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LEGEND:

Order Limits	Flood compensation area	Commencement of linear work	Ecological habitat creation and receptor site for protected species
Linear Work Centrelne (including streets)	Culvert	Commencement and termination of linear work	Temporary ecological habitat
Local Authority boundary	Bridge/structure	Termination of linear work	Open space provision, replacement open space or replacement common land
Highway Work (includes structures) Limits of Deviation	Watercourse diversion work centrelne	Bat Barn structure	Travellers site
Area excluded from Order Limits	Infiltration basin, detention basin or retention pond boundary	Construction Area - Utilities Logistic Hub	Water inlet with self-regulating valve
	Major structure	Construction Area - Main Works Compound	


P01 S8 19/10/2022 DCO Application MS RO ASB


Rev Status Rev. Date Purpose of revision Drawn Chk'd Apprv'd


Client
national highways
Project
LOWER THAMES CROSSING

Status	DCO Application	Original Size	Revision
	Application Document Number	A1	P01
	TR010032/APP/2.6	Scale	1:2500
	Drawing title		
	WORKS PLANS		
	REGULATION 5(2)(j)		
	SHEET 14 - COMPOSITE		
	Drawing Number		
	HE540039-CJV-BOP-SZZ_GN000000_DR-CX-20011		

HE540039-CJV-BOP-SZZ_GN000000_DR-CX-20011.dwg

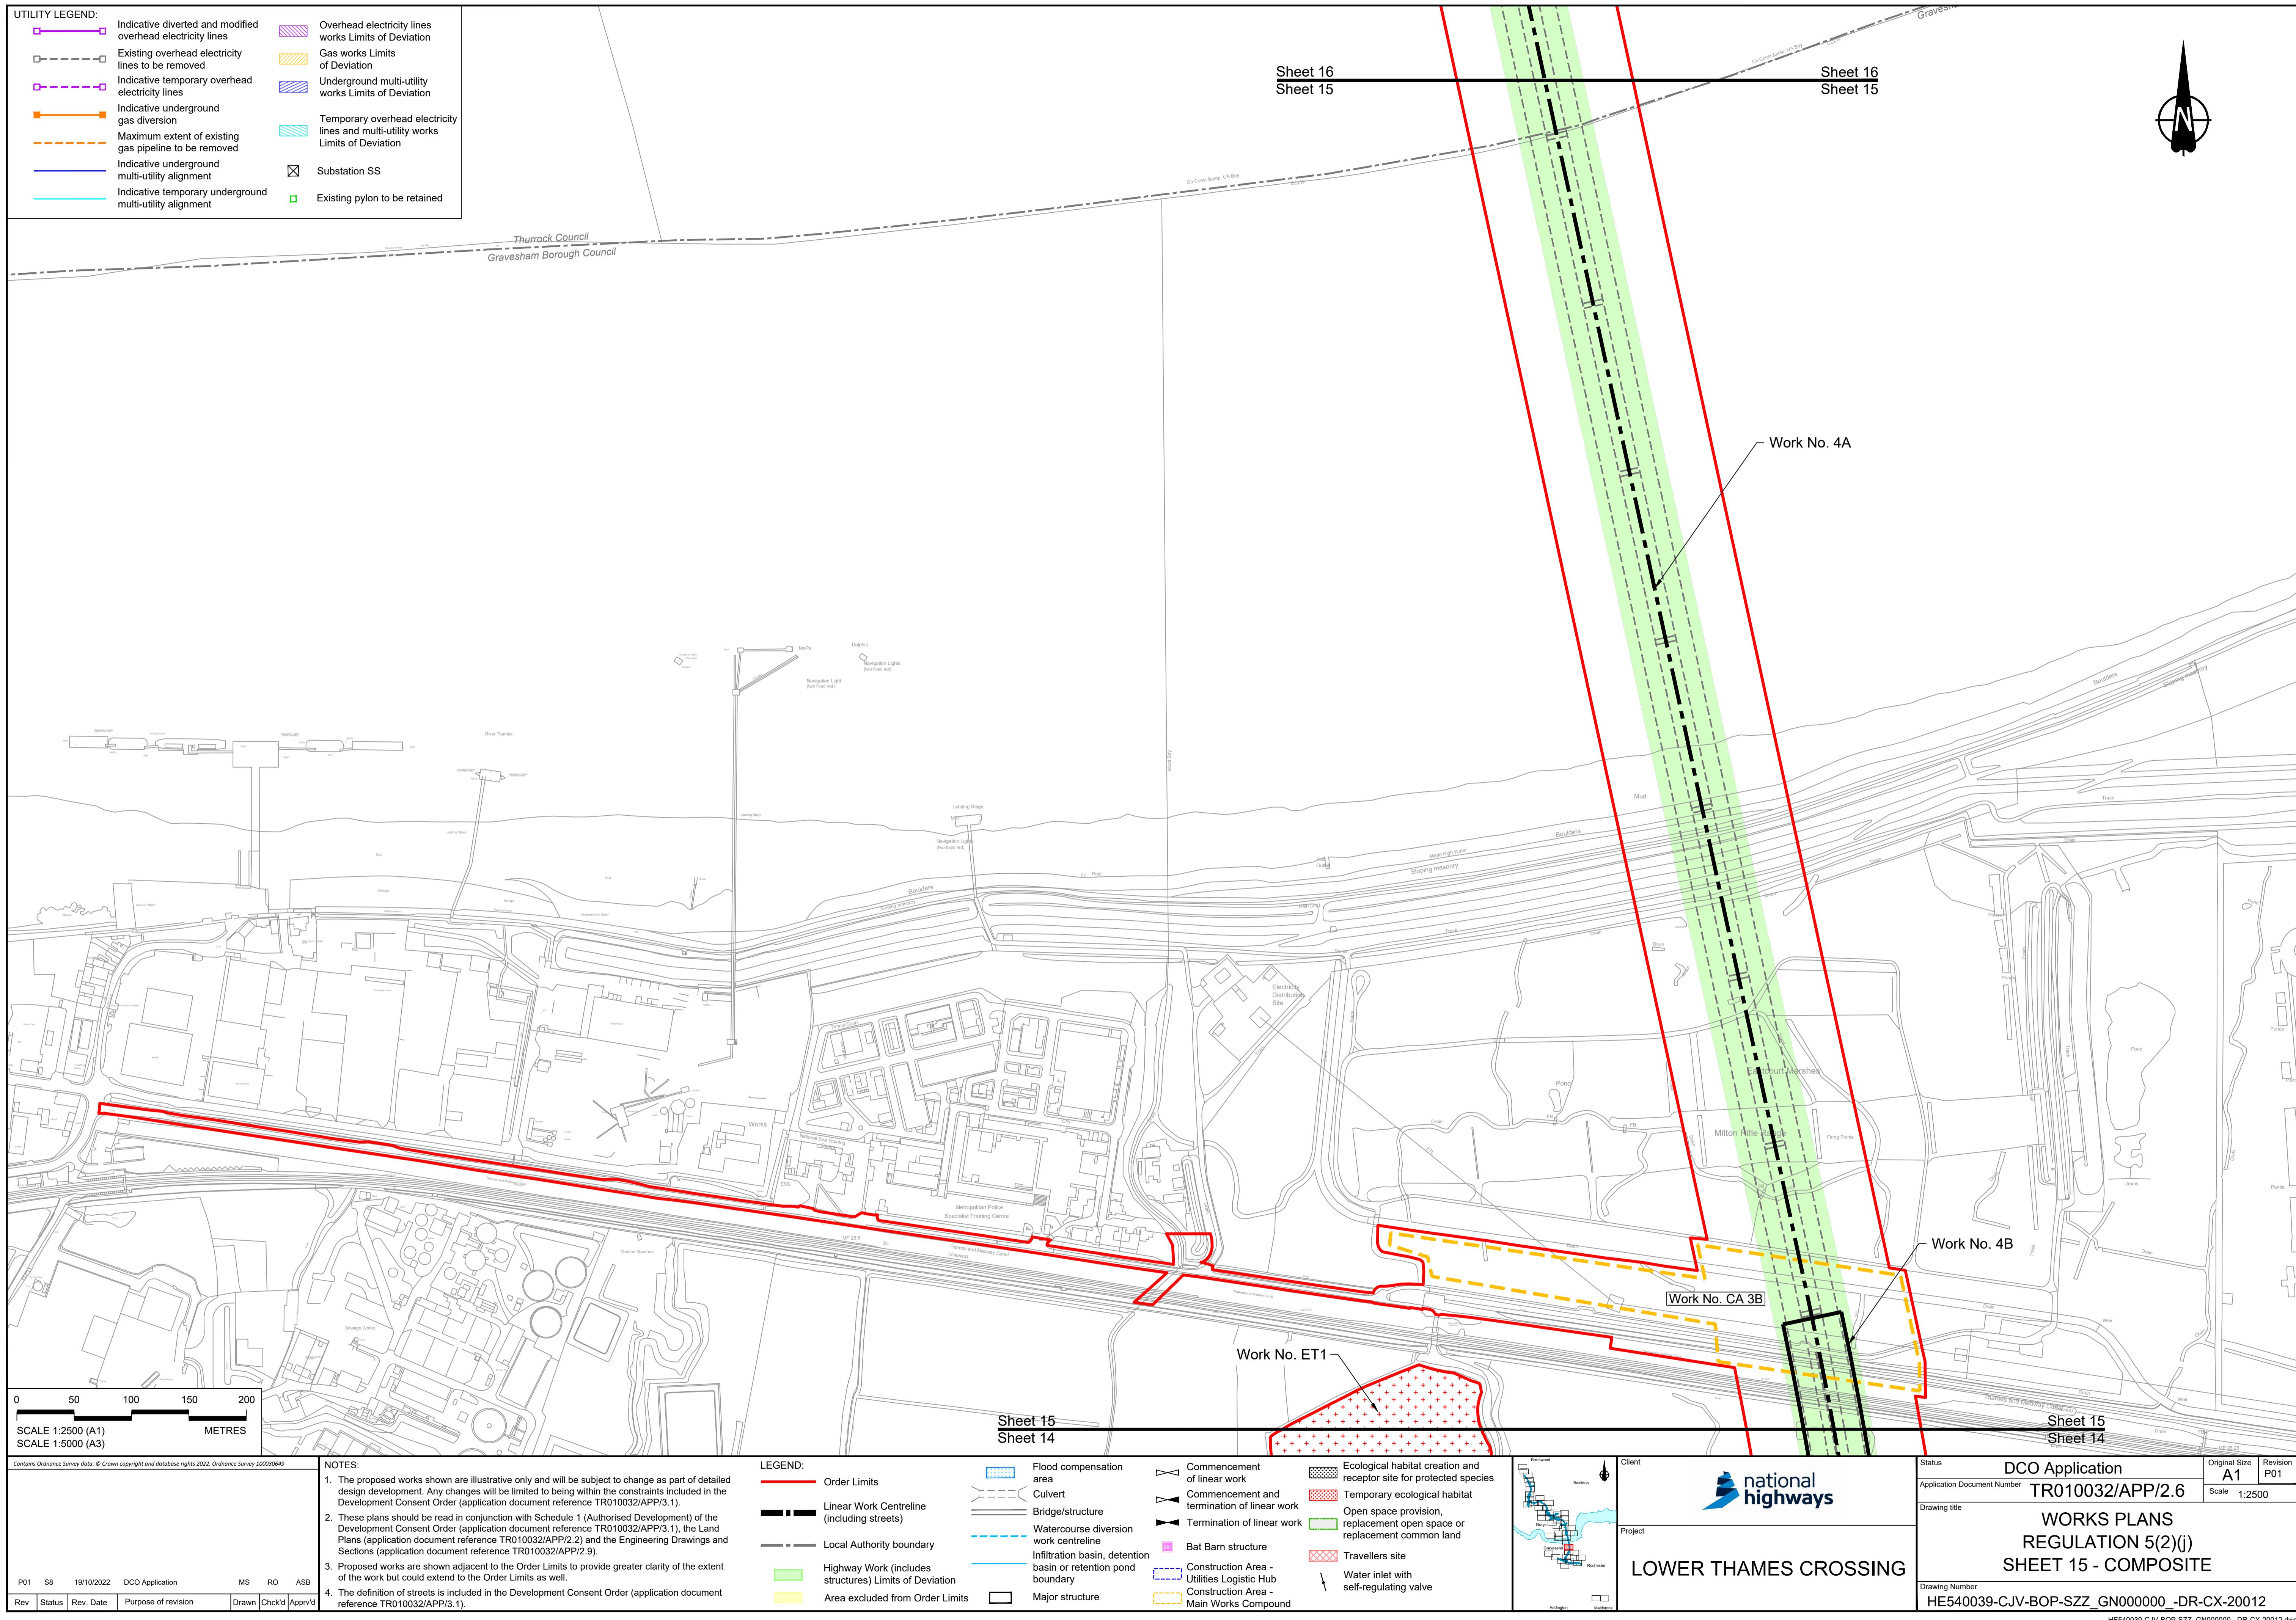


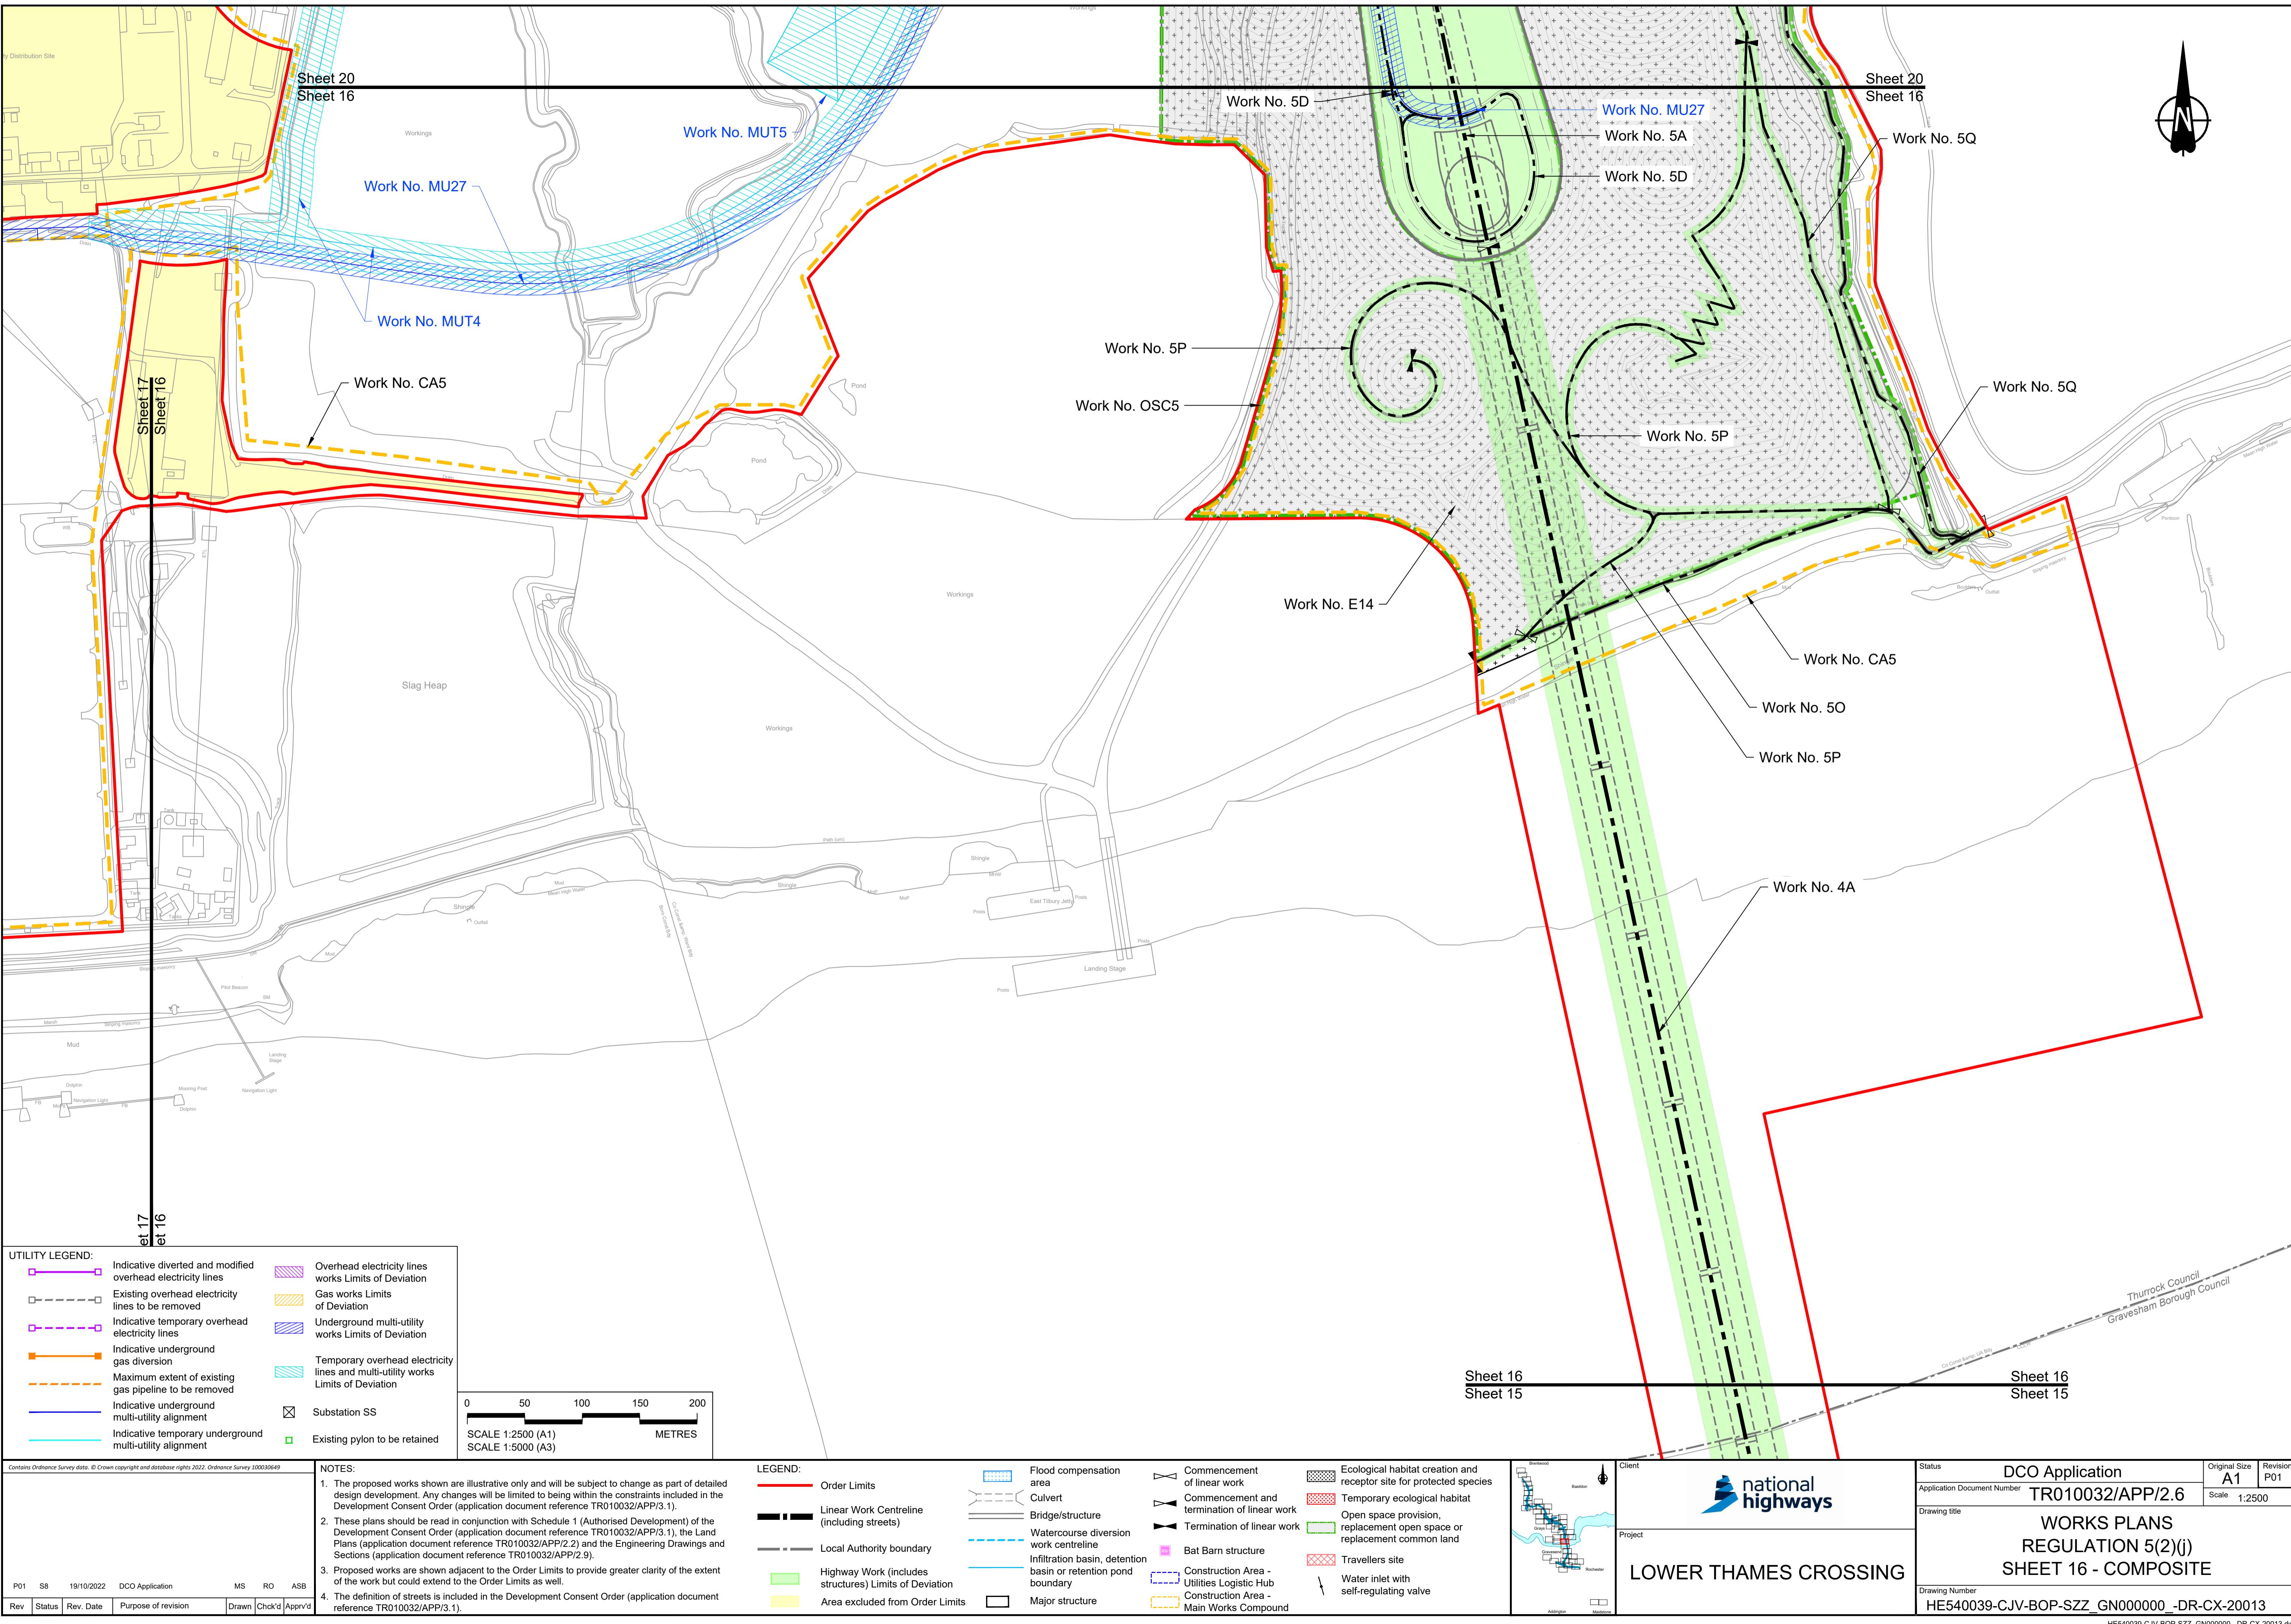


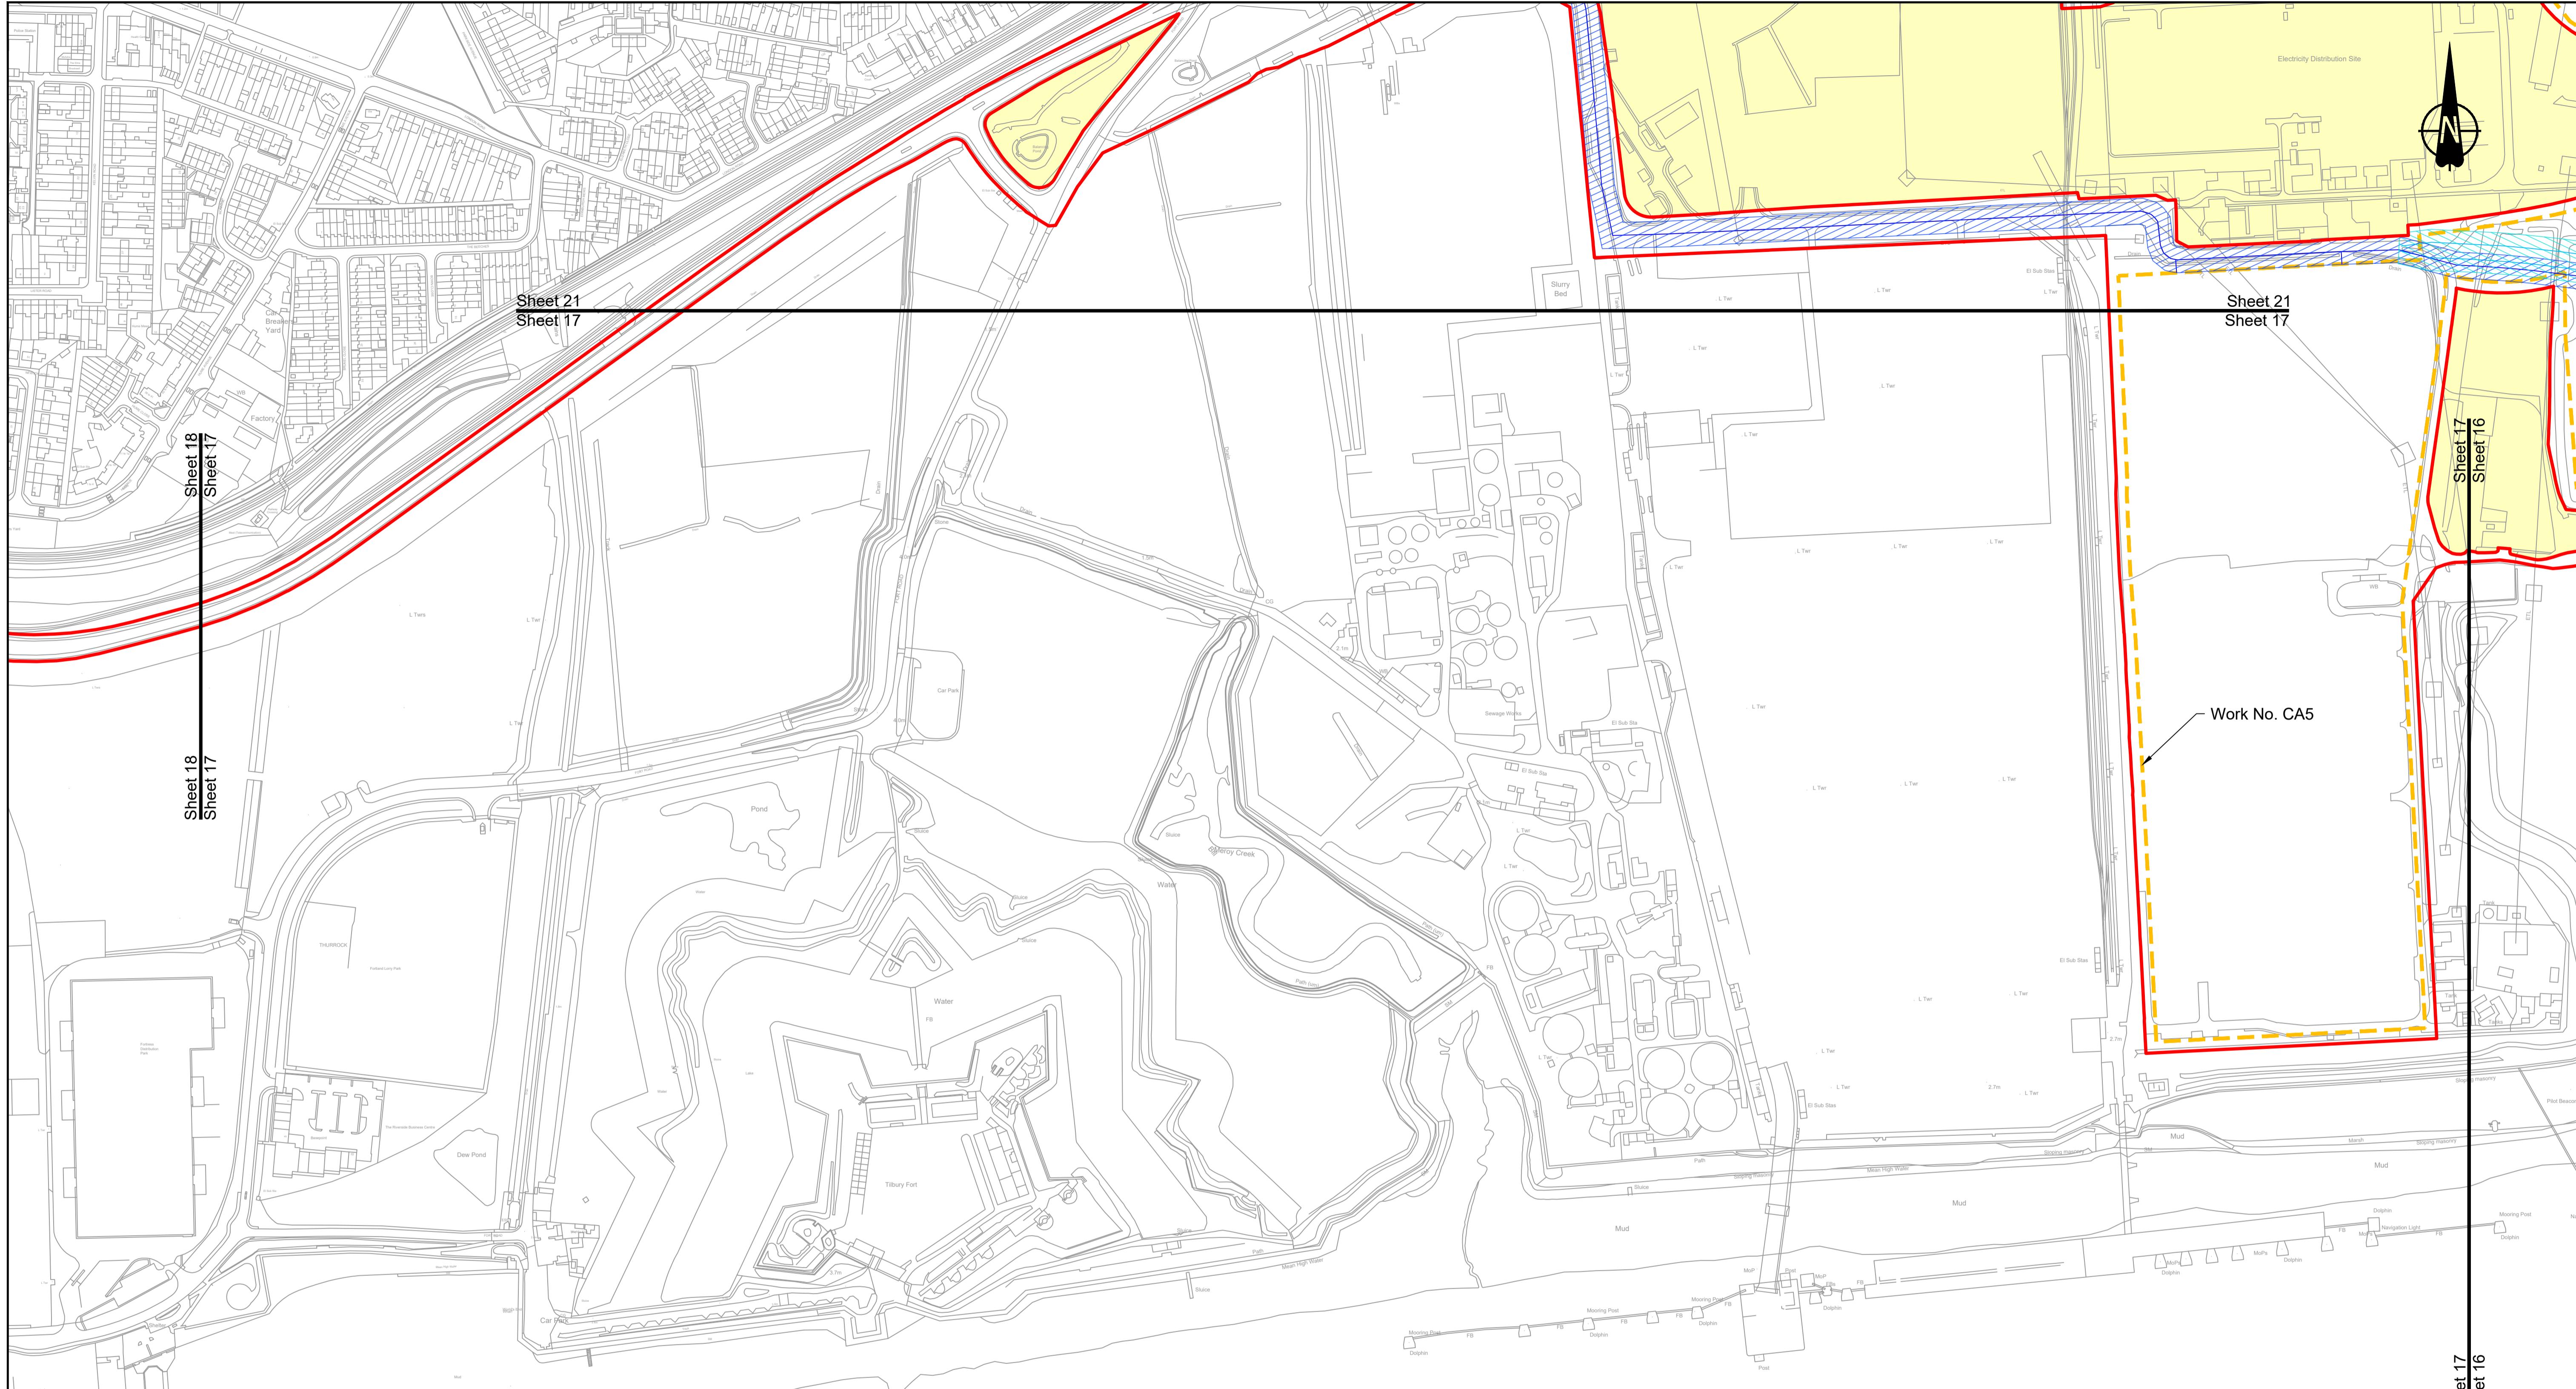

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NOTES:											
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4. The definition of streets is included in the Development Consent Order (application document reference TR010032/APP/3.1).											


P01	S8	19/10/2022	DCO Application	MS	RO	ASB
Rev	Status	Rev. Date	Purpose of revision	Drawn	Chk'd	Apprv'd

LEGEND:
— Order Limits
— Linear Work Centreline (including streets)
— Local Authority boundary
— Highway Work (includes structures) Limits of Deviation
— Flood compensation area
— Culvert
— Bridge/structure
— Watercourse diversion work centreline
— Infiltration basin, detention basin or retention pond boundary
— Major structure
— Commencement of linear work
— Commencement and termination of linear work
— Termination of linear work
— Ecological habitat creation and receptor site for protected species
— Temporary ecological habitat
— Open space provision, replacement open space or replacement common land
— Travellers site
— Construction Area - Utilities Logistic Hub
— Construction Area - Main Works Compound
— Area excluded from Order Limits

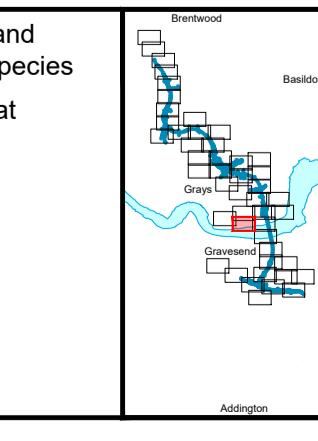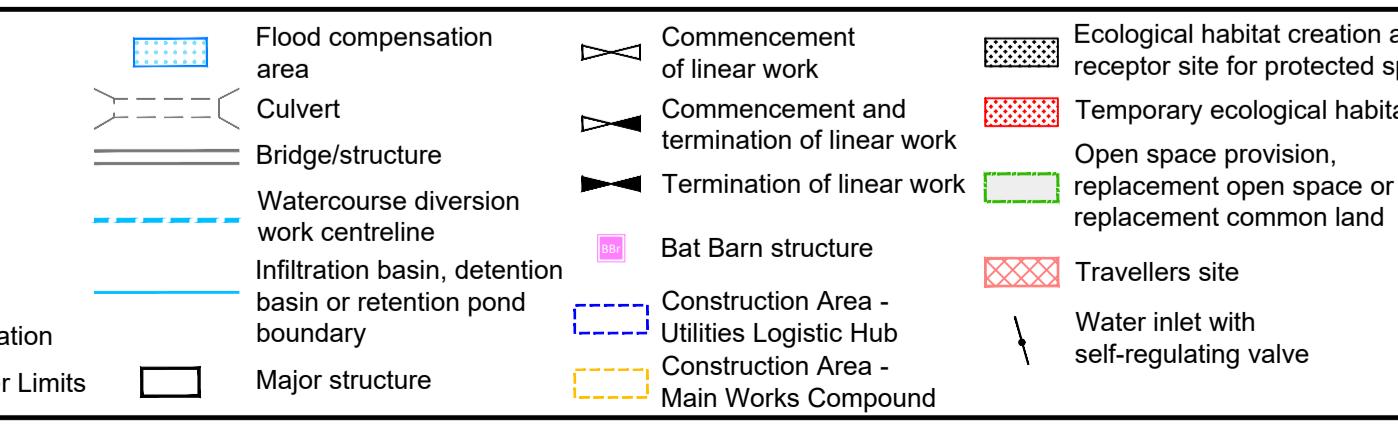

Client: **national highways**
 Project: LOWER THAMES CROSSING
 Drawing Number: HE540039-CJV-BOP-SZZ_GN0000000_DR-CX-20014

Status	DCO Application	Original Size
Application Document Number	TR010032/APP/2.6	Revision P01
Scale	1:2500	
Drawing title	WORKS PLANS	
	REGULATION 5(2)(j)	
	SHEET 17 - COMPOSITE	
Drawing Number	HE540039-CJV-BOP-SZZ_GN0000000_DR-CX-20014	

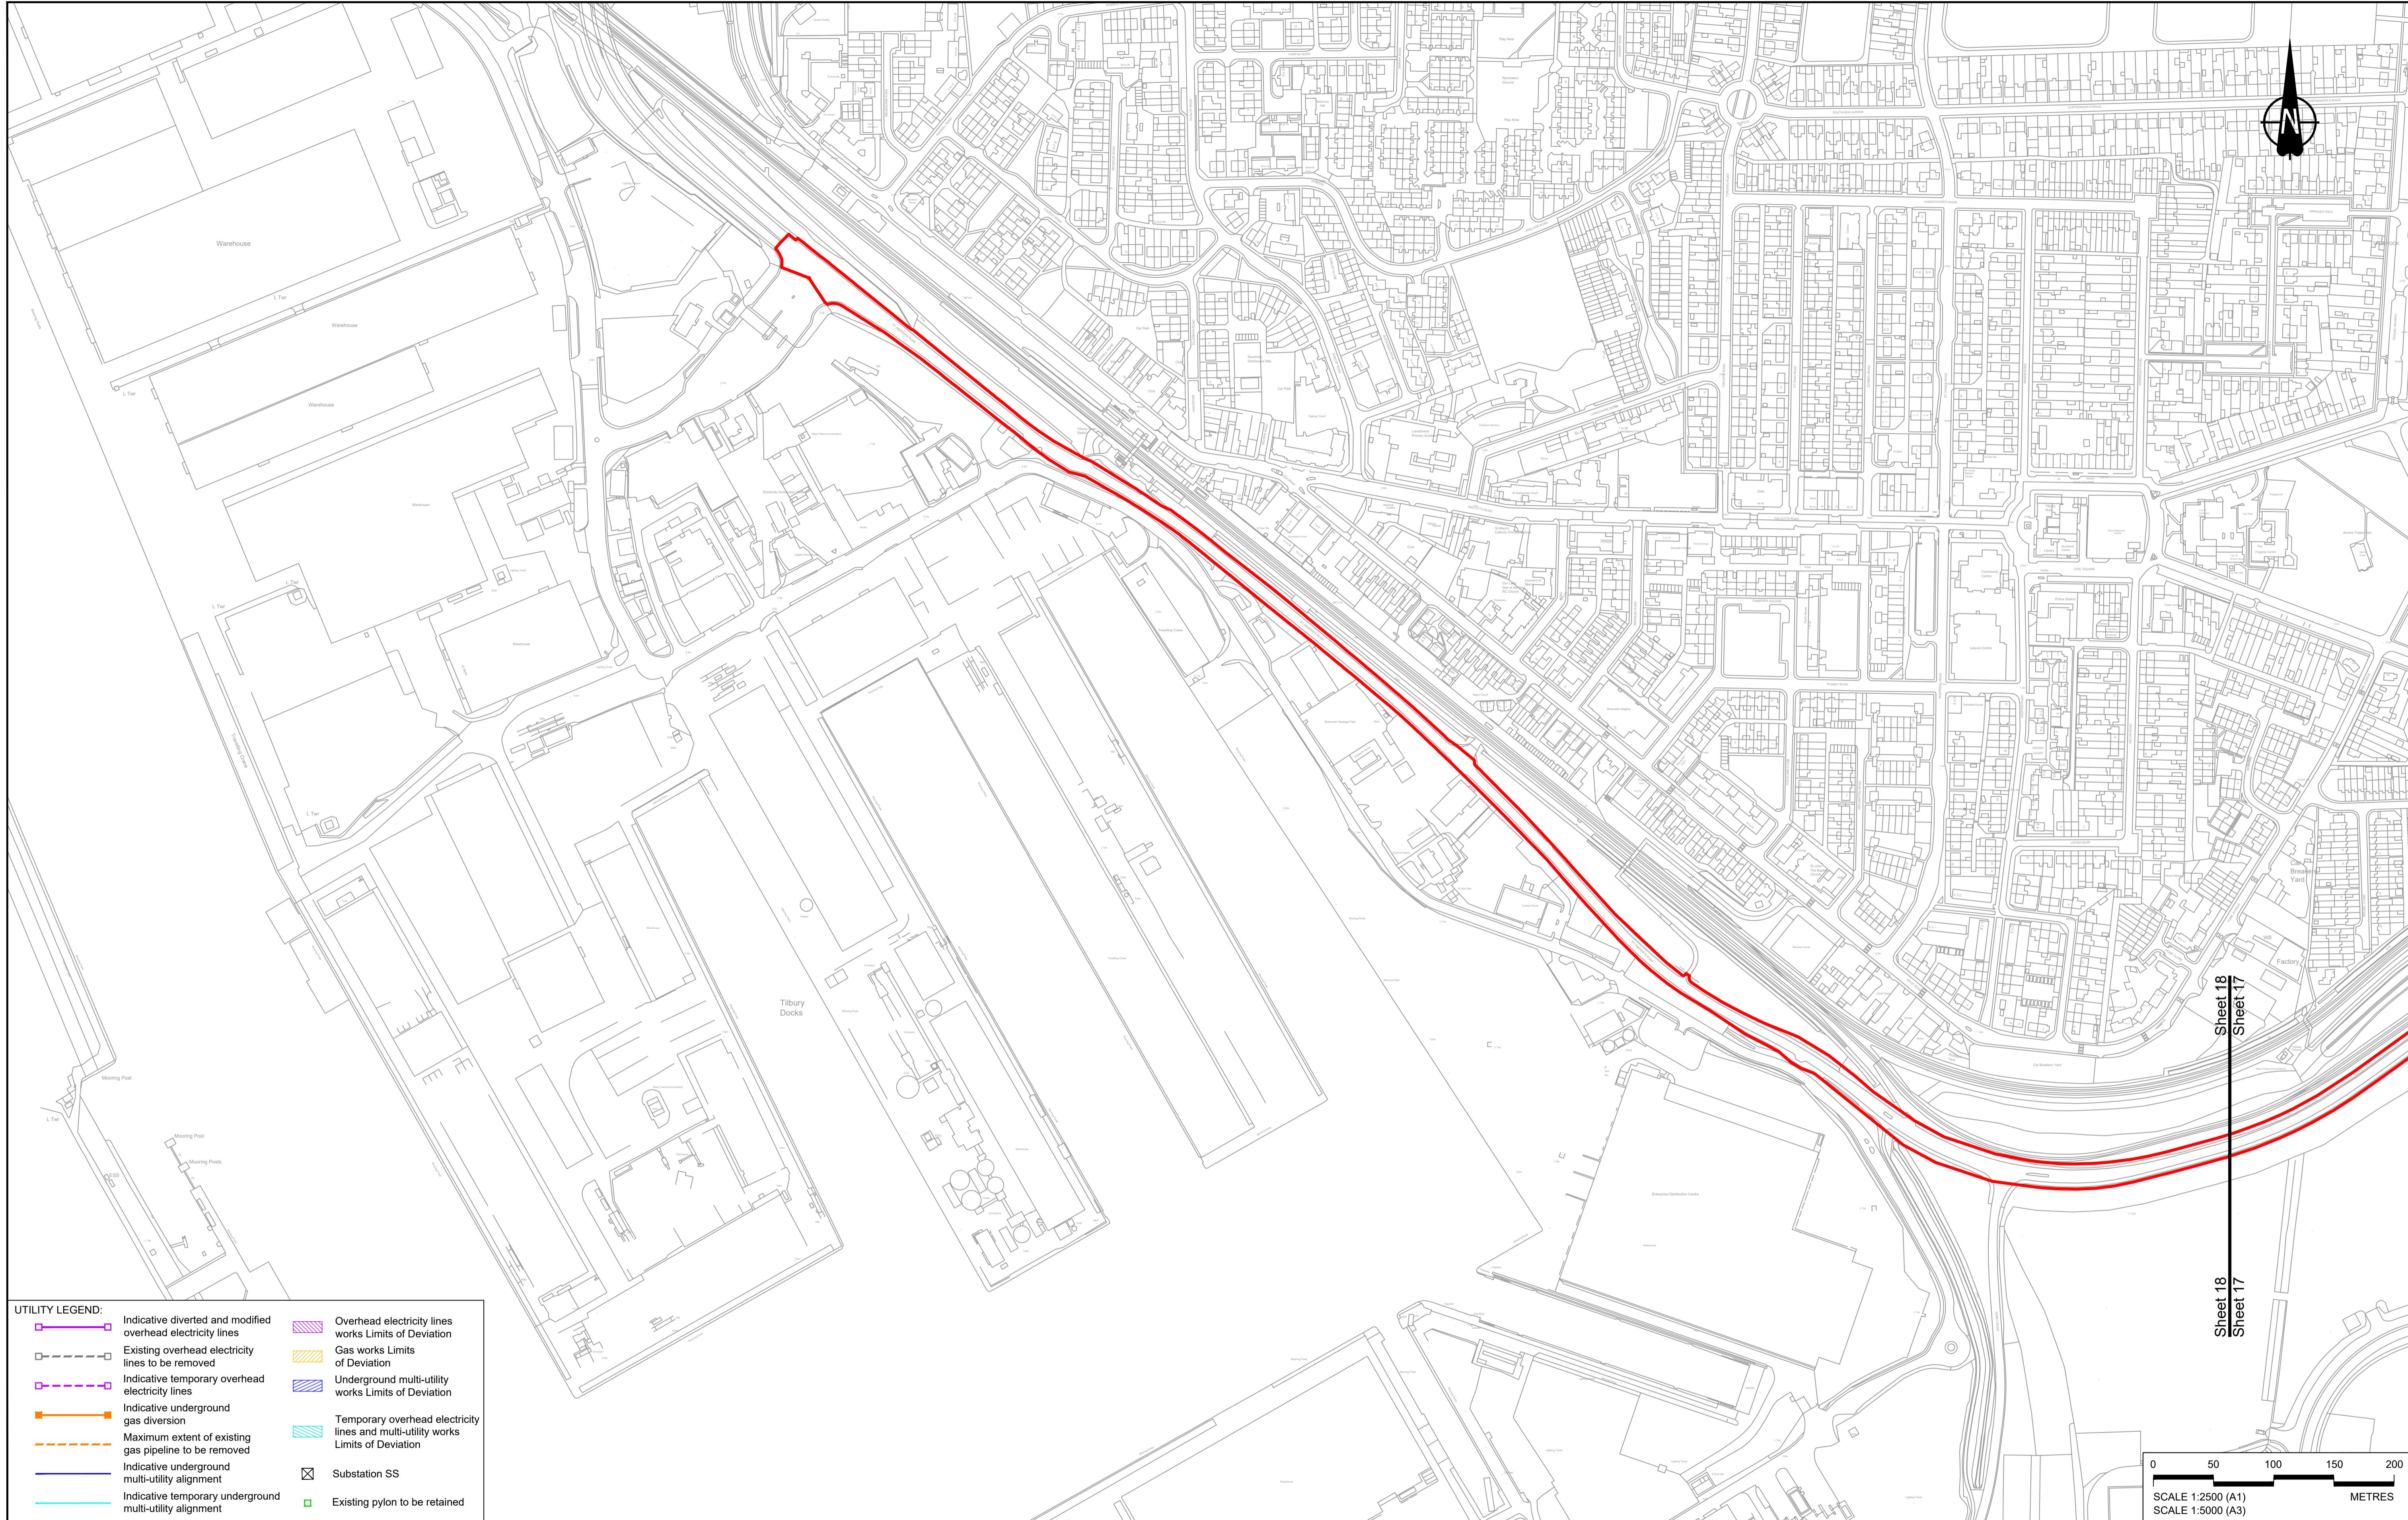

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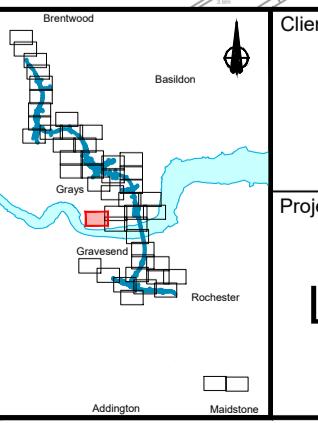
P01 S8 19/10/2022 DCO Application MS RO ASB

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LEGEND:
— Order Limits
— Linear Work Centreline (including streets)
— Local Authority boundary
— Highway Work (includes structures) Limits of Deviation
— Area excluded from Order Limits


Flood compensation area
— Culvert
— Bridge/structure
--- Watercourse diversion work centreline
— Infiltration basin, detention basin or retention pond boundary
— Major structure


Commencement of linear work
— Commencement and termination of linear work
— Termination of linear work
■ Bat Barn structure
— Construction Area - Utilities Logistic Hub
— Construction Area - Main Works Compound
— Water inlet with self-regulating valve



Client: **national highways**
Project: **LOWER THAMES CROSSING**
Drawing Number: HE540039-CJV-BOP-SZZ_GN000000_DR-CX-20015

Status: **DCO Application**
Original Size: **A1**
Revision: **P01**
Application Document Number: **TR010032/APP/2.6**
Scale: **1:2500**
Drawing title: **WORKS PLANS REGULATION 5(2)(j)**
SHEET 18 - COMPOSITE
Drawing Number: **HE540039-CJV-BOP-SZZ_GN000000_DR-CX-20015**
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P01 S8 19/10/2022 DCO Application MS RO ASB

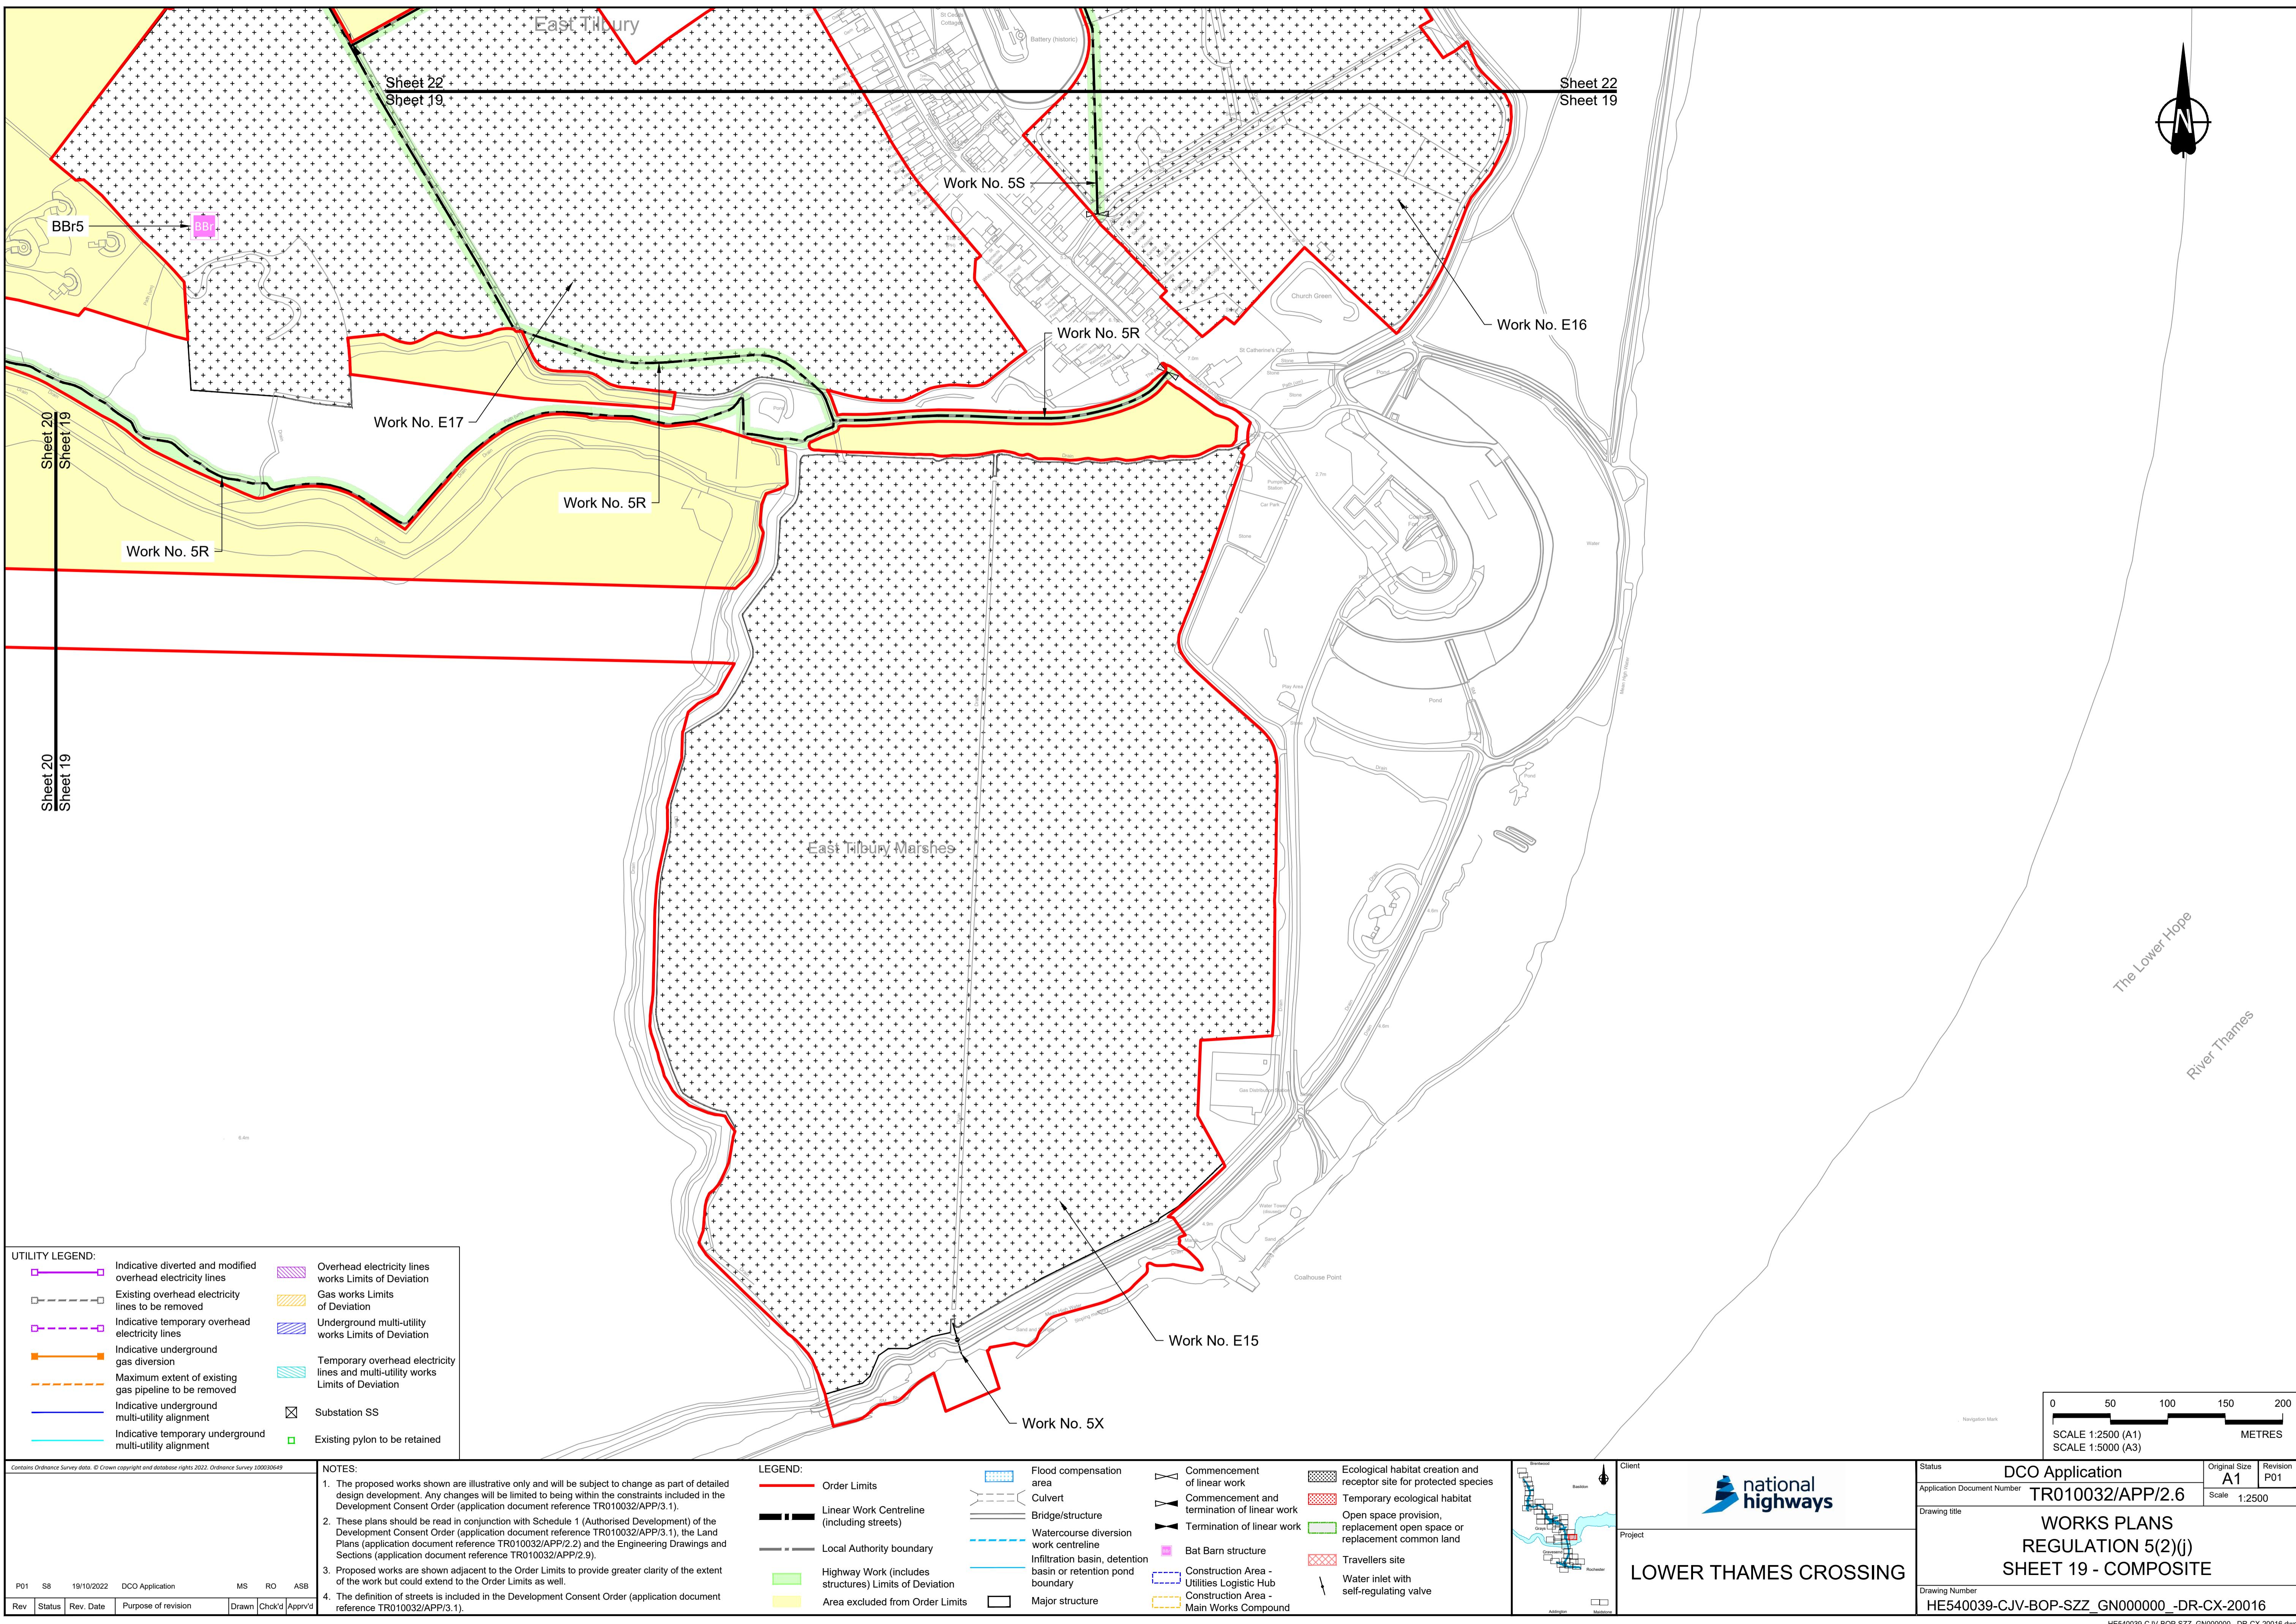Rev Status Rev. Date Purpose of revision Drawn Chk'd Apprv'd
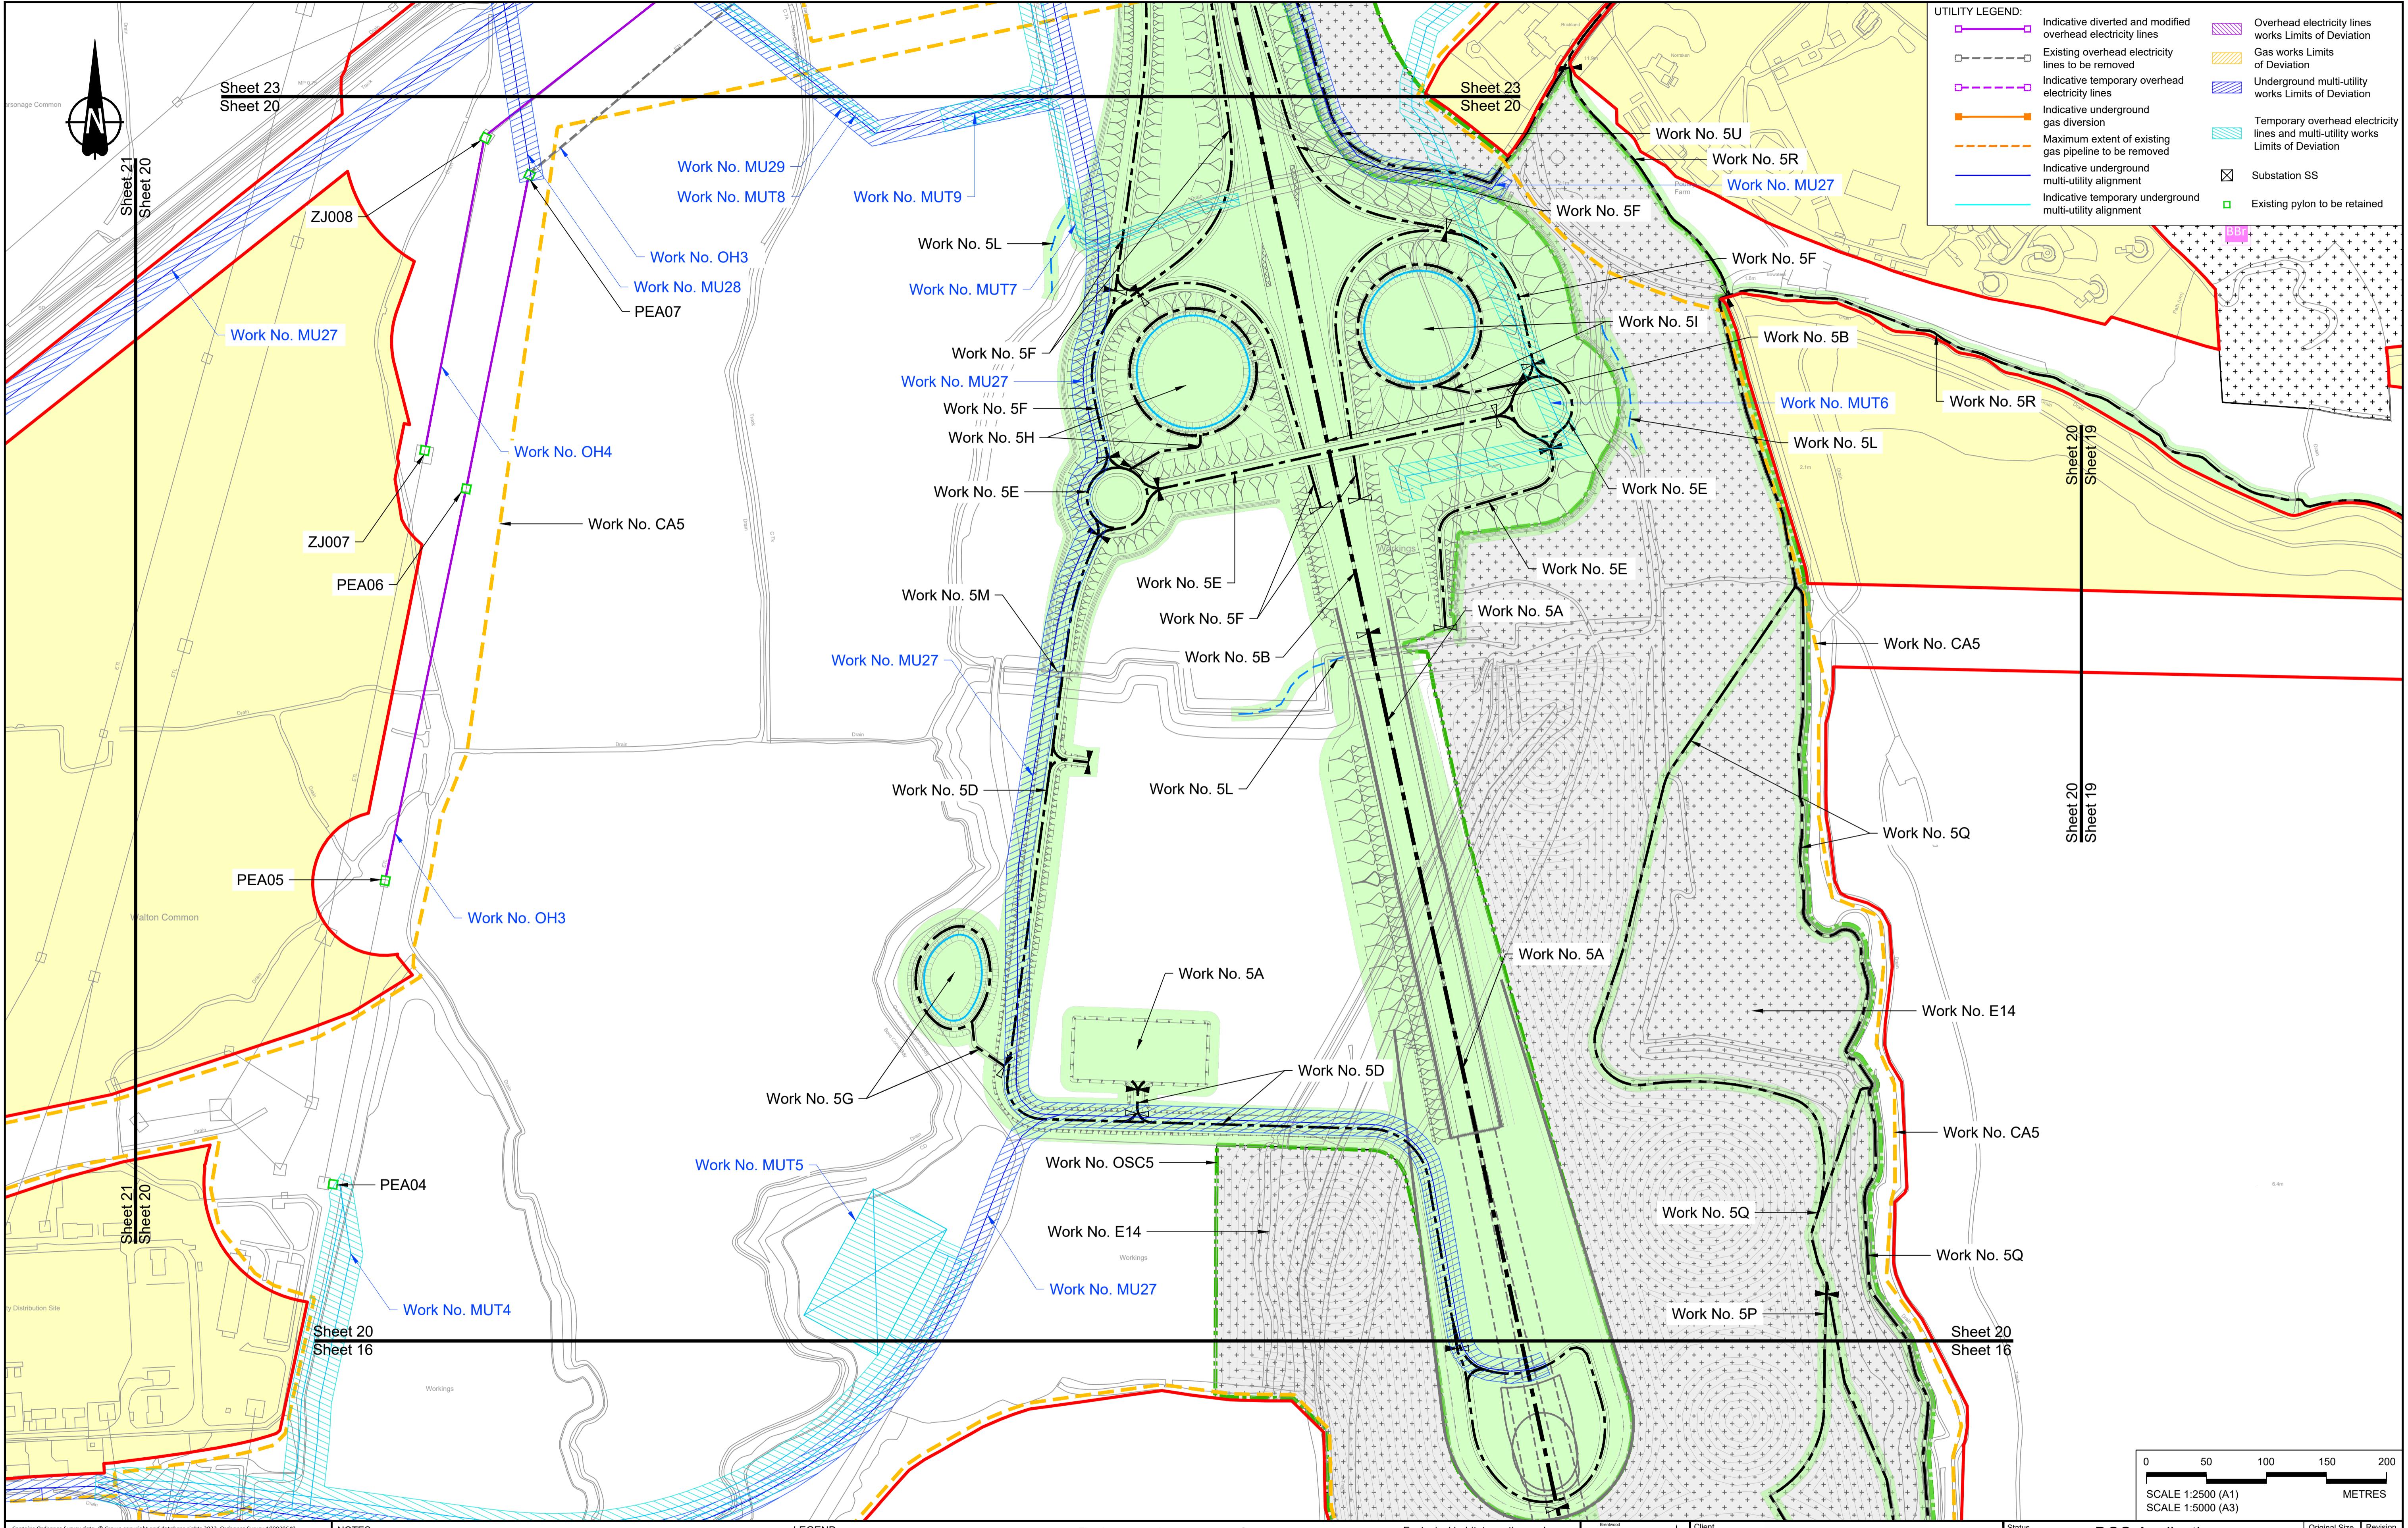
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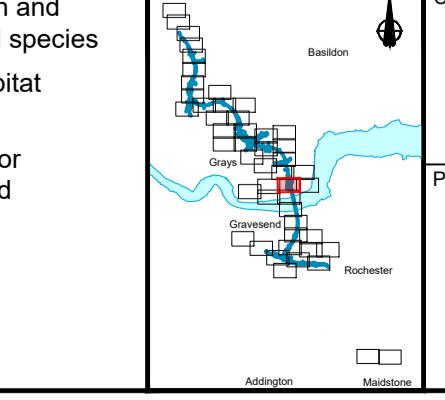
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LEGEND:

Order Limits	Flood compensation area	Commencement of linear work	Ecological habitat creation and receptor site for protected species
Linear Work Centreline (including streets)	Culvert	Commencement and termination of linear work	Temporary ecological habitat
Local Authority boundary	Bridge/structure	Termination of linear work	Open space provision, replacement open space or replacement common land
Highway Work (includes structures) Limits of Deviation	Watercourse diversion work centreline	Infiltration basin, detention basin or retention pond boundary	Bat Barn structure
			Construction Area - Utilities Logistic Hub
			Construction Area - Main Works Compound
			Major structure

LEGEND:

Order Limits	Flood compensation area	Commencement of linear work	Ecological habitat creation and receptor site for protected species
Linear Work Centreline (including streets)	Culvert	Commencement and termination of linear work	Temporary ecological habitat
Local Authority boundary	Bridge/structure	Termination of linear work	Open space provision, replacement open space or replacement common land
Highway Work (includes structures) Limits of Deviation	Watercourse diversion work centreline	Infiltration basin, detention basin or retention pond boundary	Bat Barn structure
			Travellers site
			Construction Area - Utilities Logistic Hub
			Construction Area - Main Works Compound
			Major structure



Status: DCO Application
Original Size: A1
Revision: P01
Application Document Number: TR010032/APP/2.6
Scale: 1:2500
Drawing title: WORKS PLANS
Project: LOWER THAMES CROSSING
Drawing Number: HE540039-CJV-BOP-SZZ_GN000000_DR-CX-20017

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